


1314 EHRINGHAUS STREET ELIZABETH CITY, NORTH CAROLINA

Drawn COC Project No TBD Date 4/15/09 Scale 1" = 40'

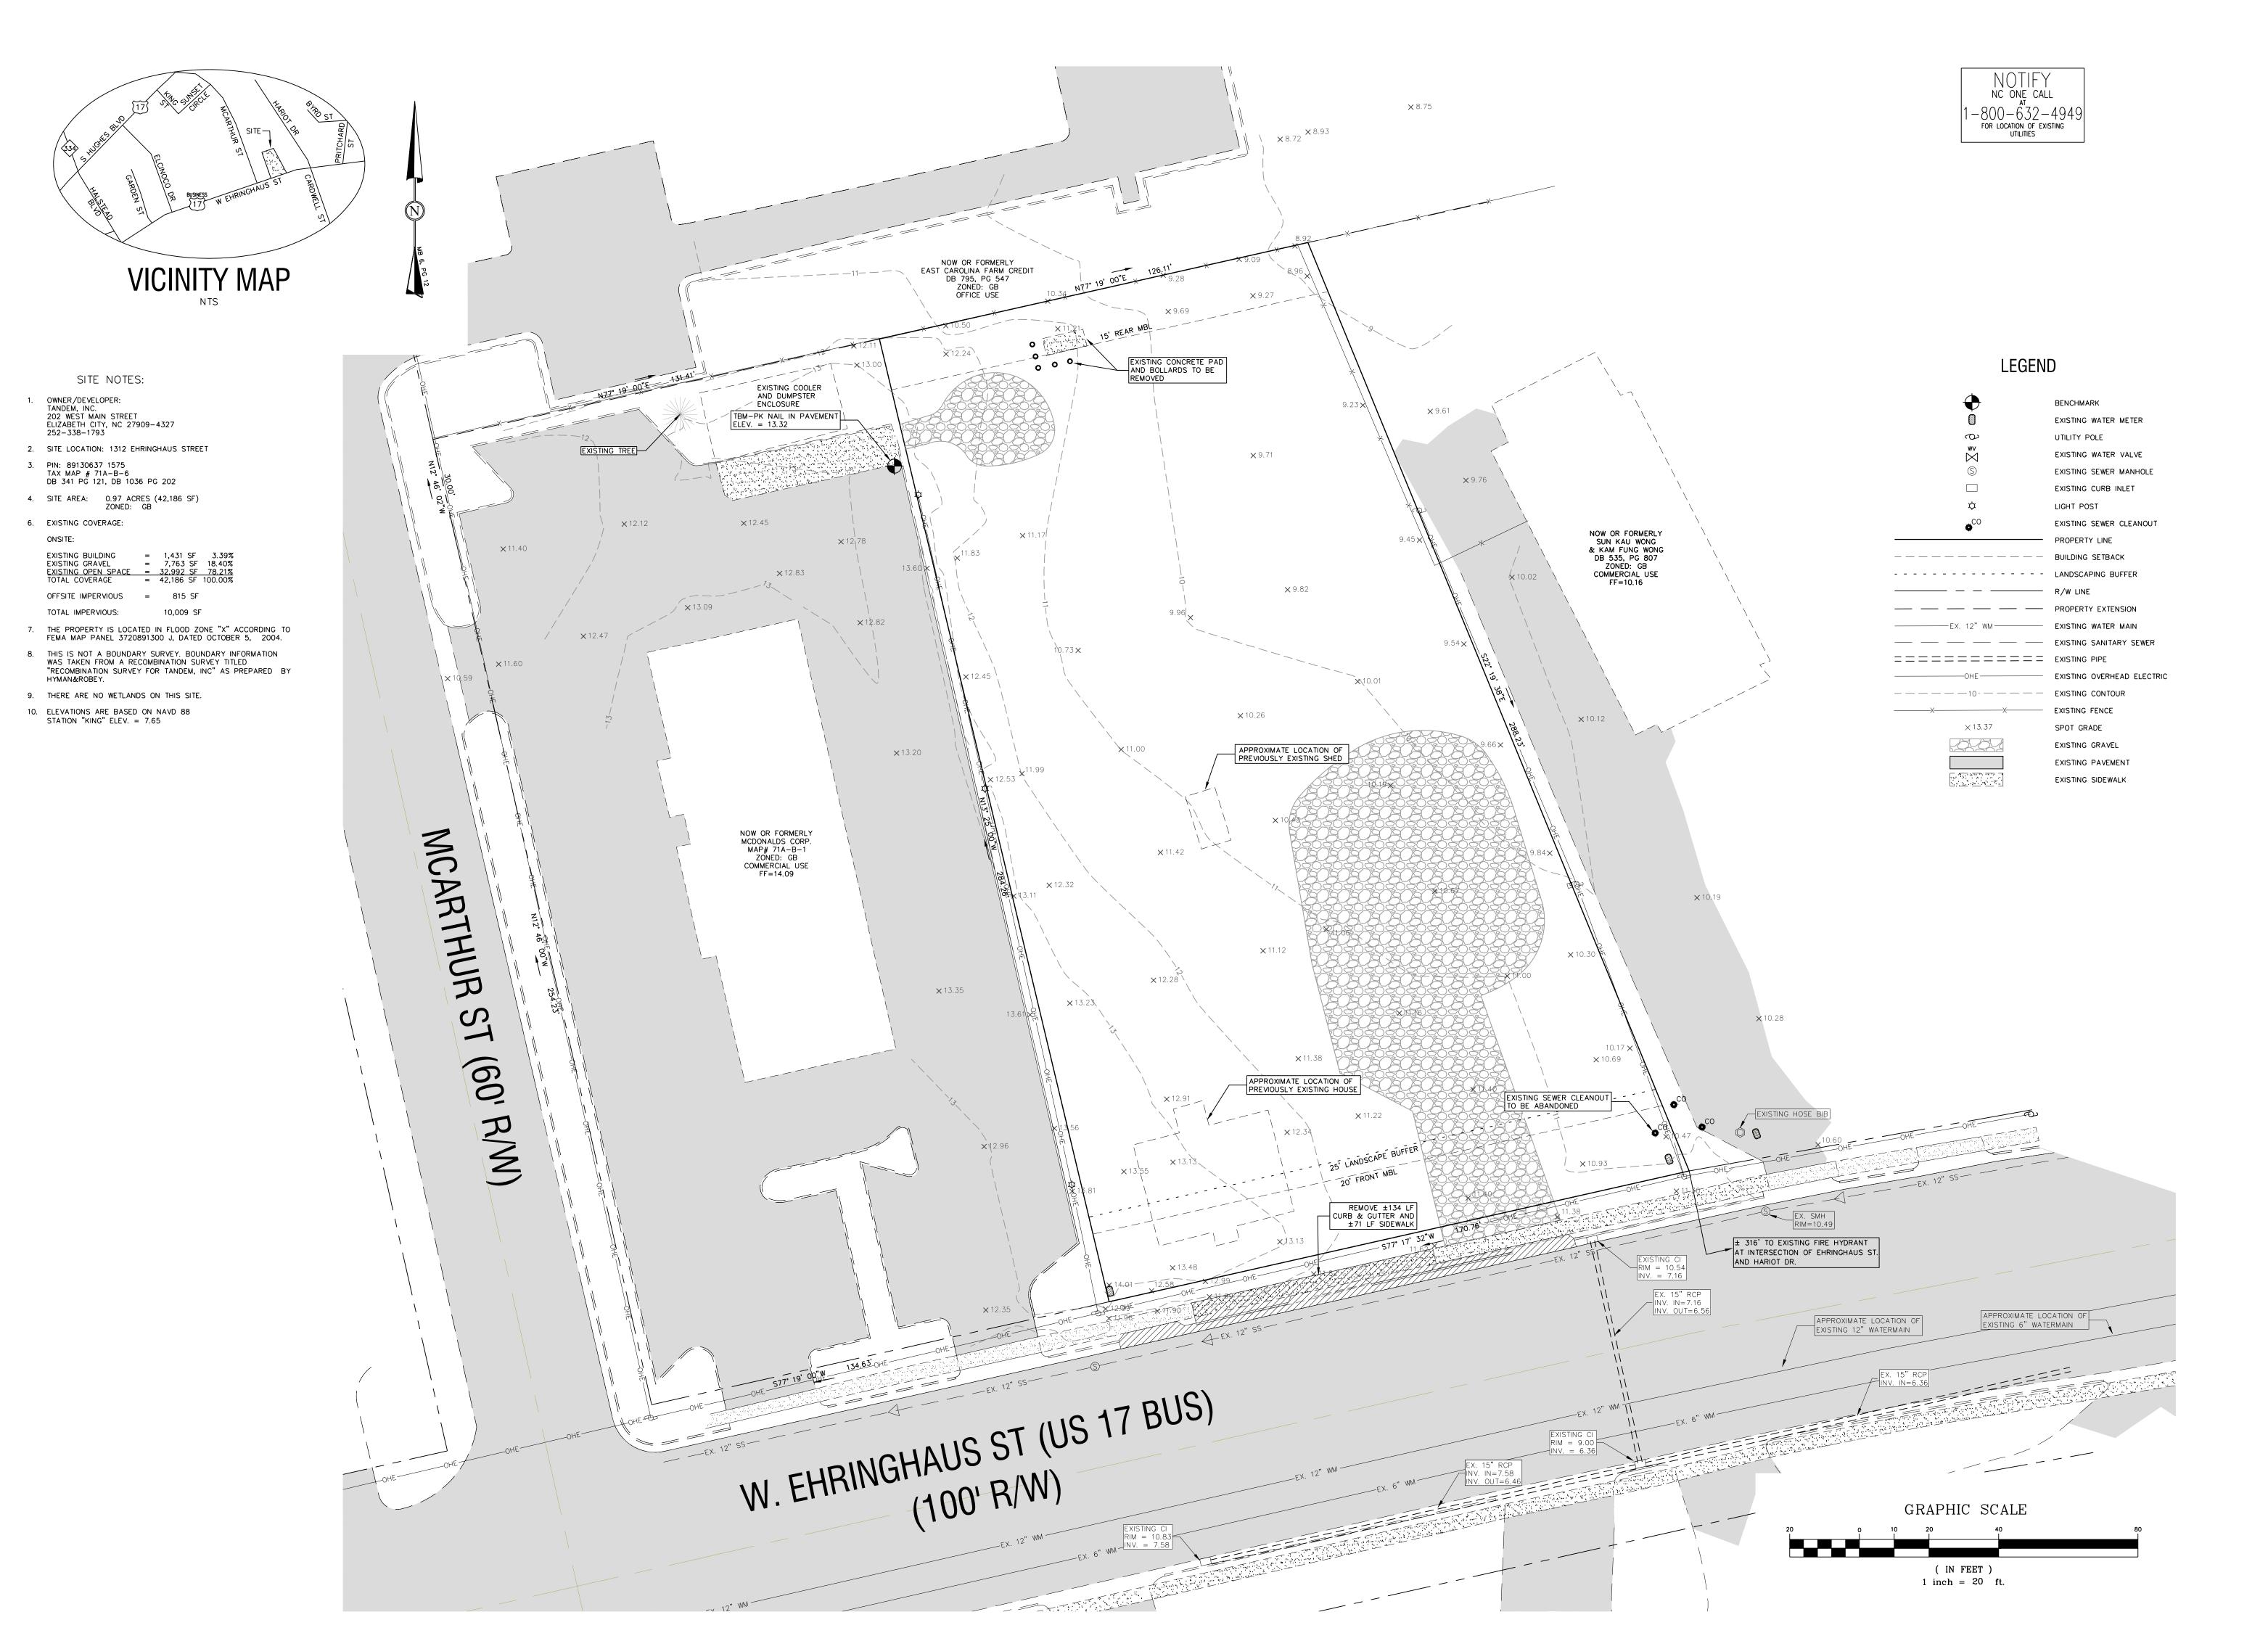





Tandem, Inc. Elizabeth City

Pasquotank County

North Carolina

RELEASED FOR **CONSTRUCTION**

Project #: 090120
Drawing #: 090120 - Site
Drawn: BLR
Checked: KDH
Approved: SCR
Date: 08/07/09
Sheet #: 1/6


Scale: 1:20 REVISIONS: NUM. DATE


1 12-03-09 2 2-02-10

3 2-23-10


Existing Topo & Demo Plan

SHEET NUMBER:

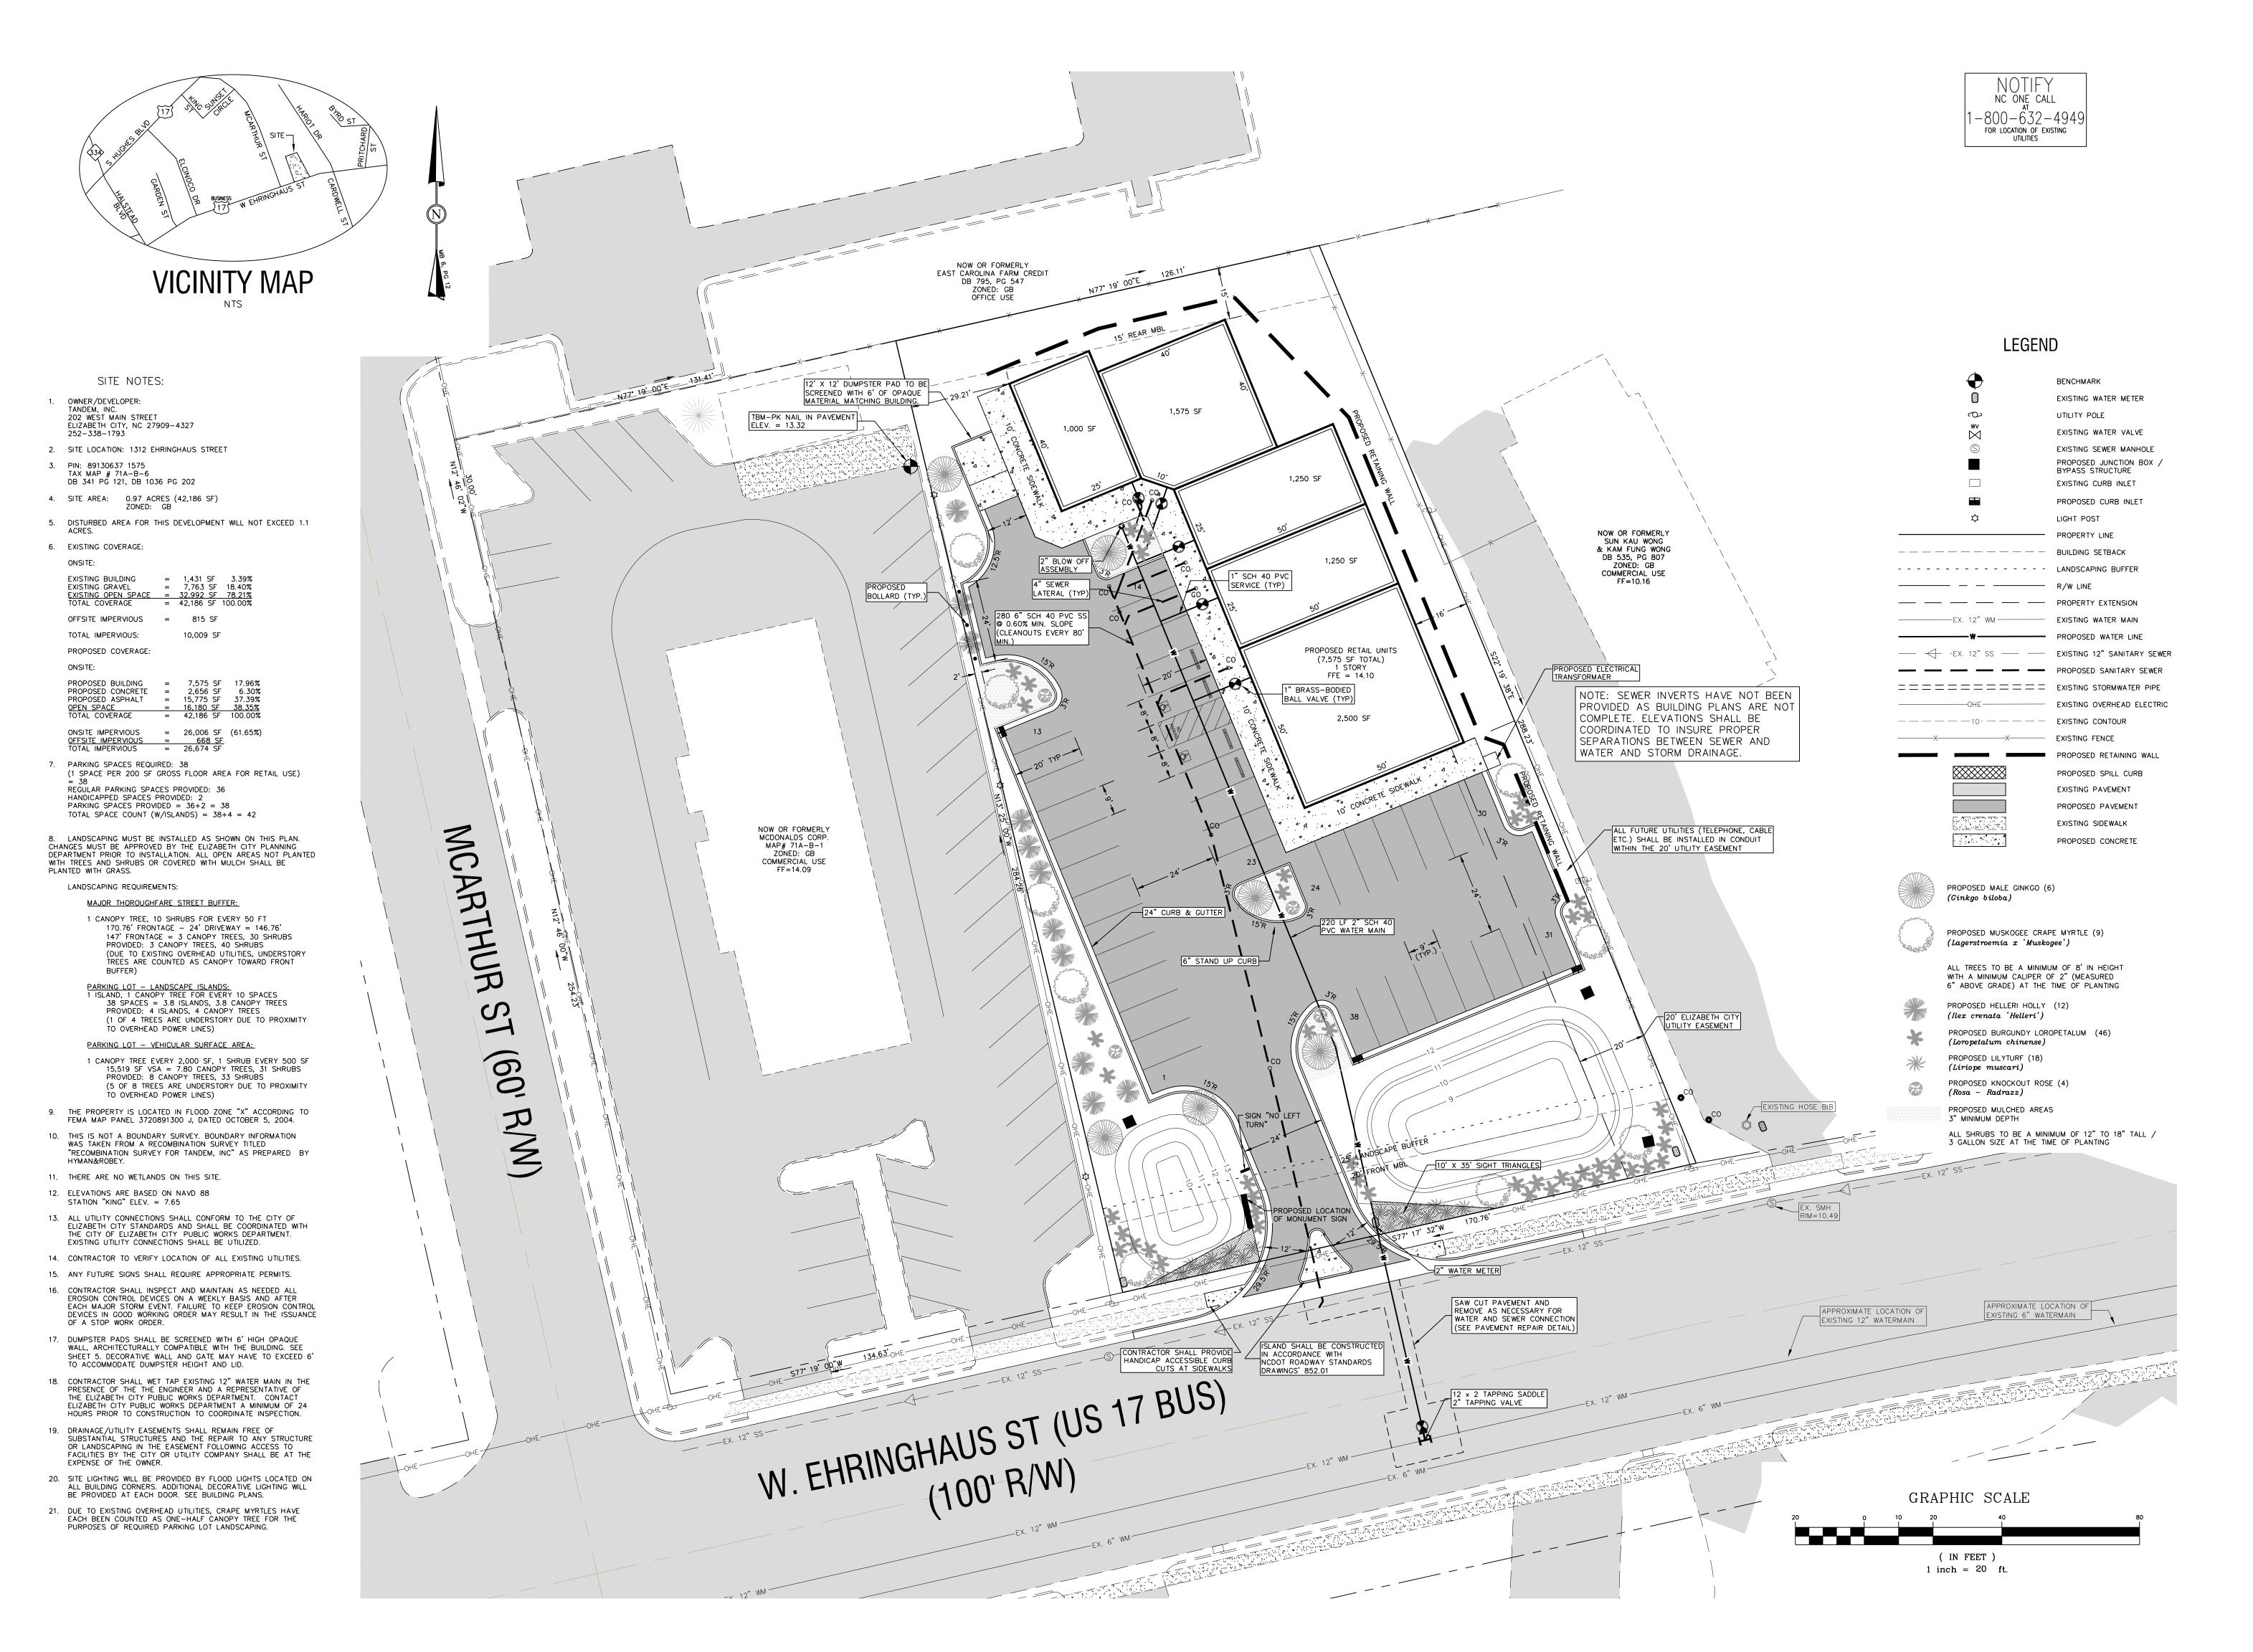

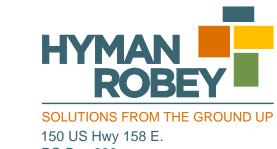

150 US Hwy 158 E.
PO Box 339
Camden, NC 27921
(252) 338-2913
(252) 338-5552 fax
www.hymanrobey.com

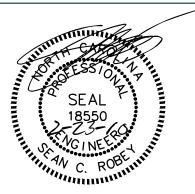

Tandem, Inc.

Elizabeth City

Pasquotank County

North Carolina

RELEASED
FOR
CONSTRUCTION
KEY PLAN:

Project #: 090120
Drawing #: 090120 - Site
Drawn: BLR
Checked: KDH
Approved: SCR
Date: 08/07/09
Sheet #: 2/6
Scale: 1:20

Sheet #: 2/6 Scale: 1:20 REVISIONS: NUM. DATE D

NUM. DATE DESCRIPTION

1 12-03-09 TRC & Removal of connecting drive

2 2-02-10 Per Planning and NCDOT

NCDOT


3 2-23-10 Released For Construction

SHEET TITLE:

Site & Utility Plan

SHEET NUMBER:

2

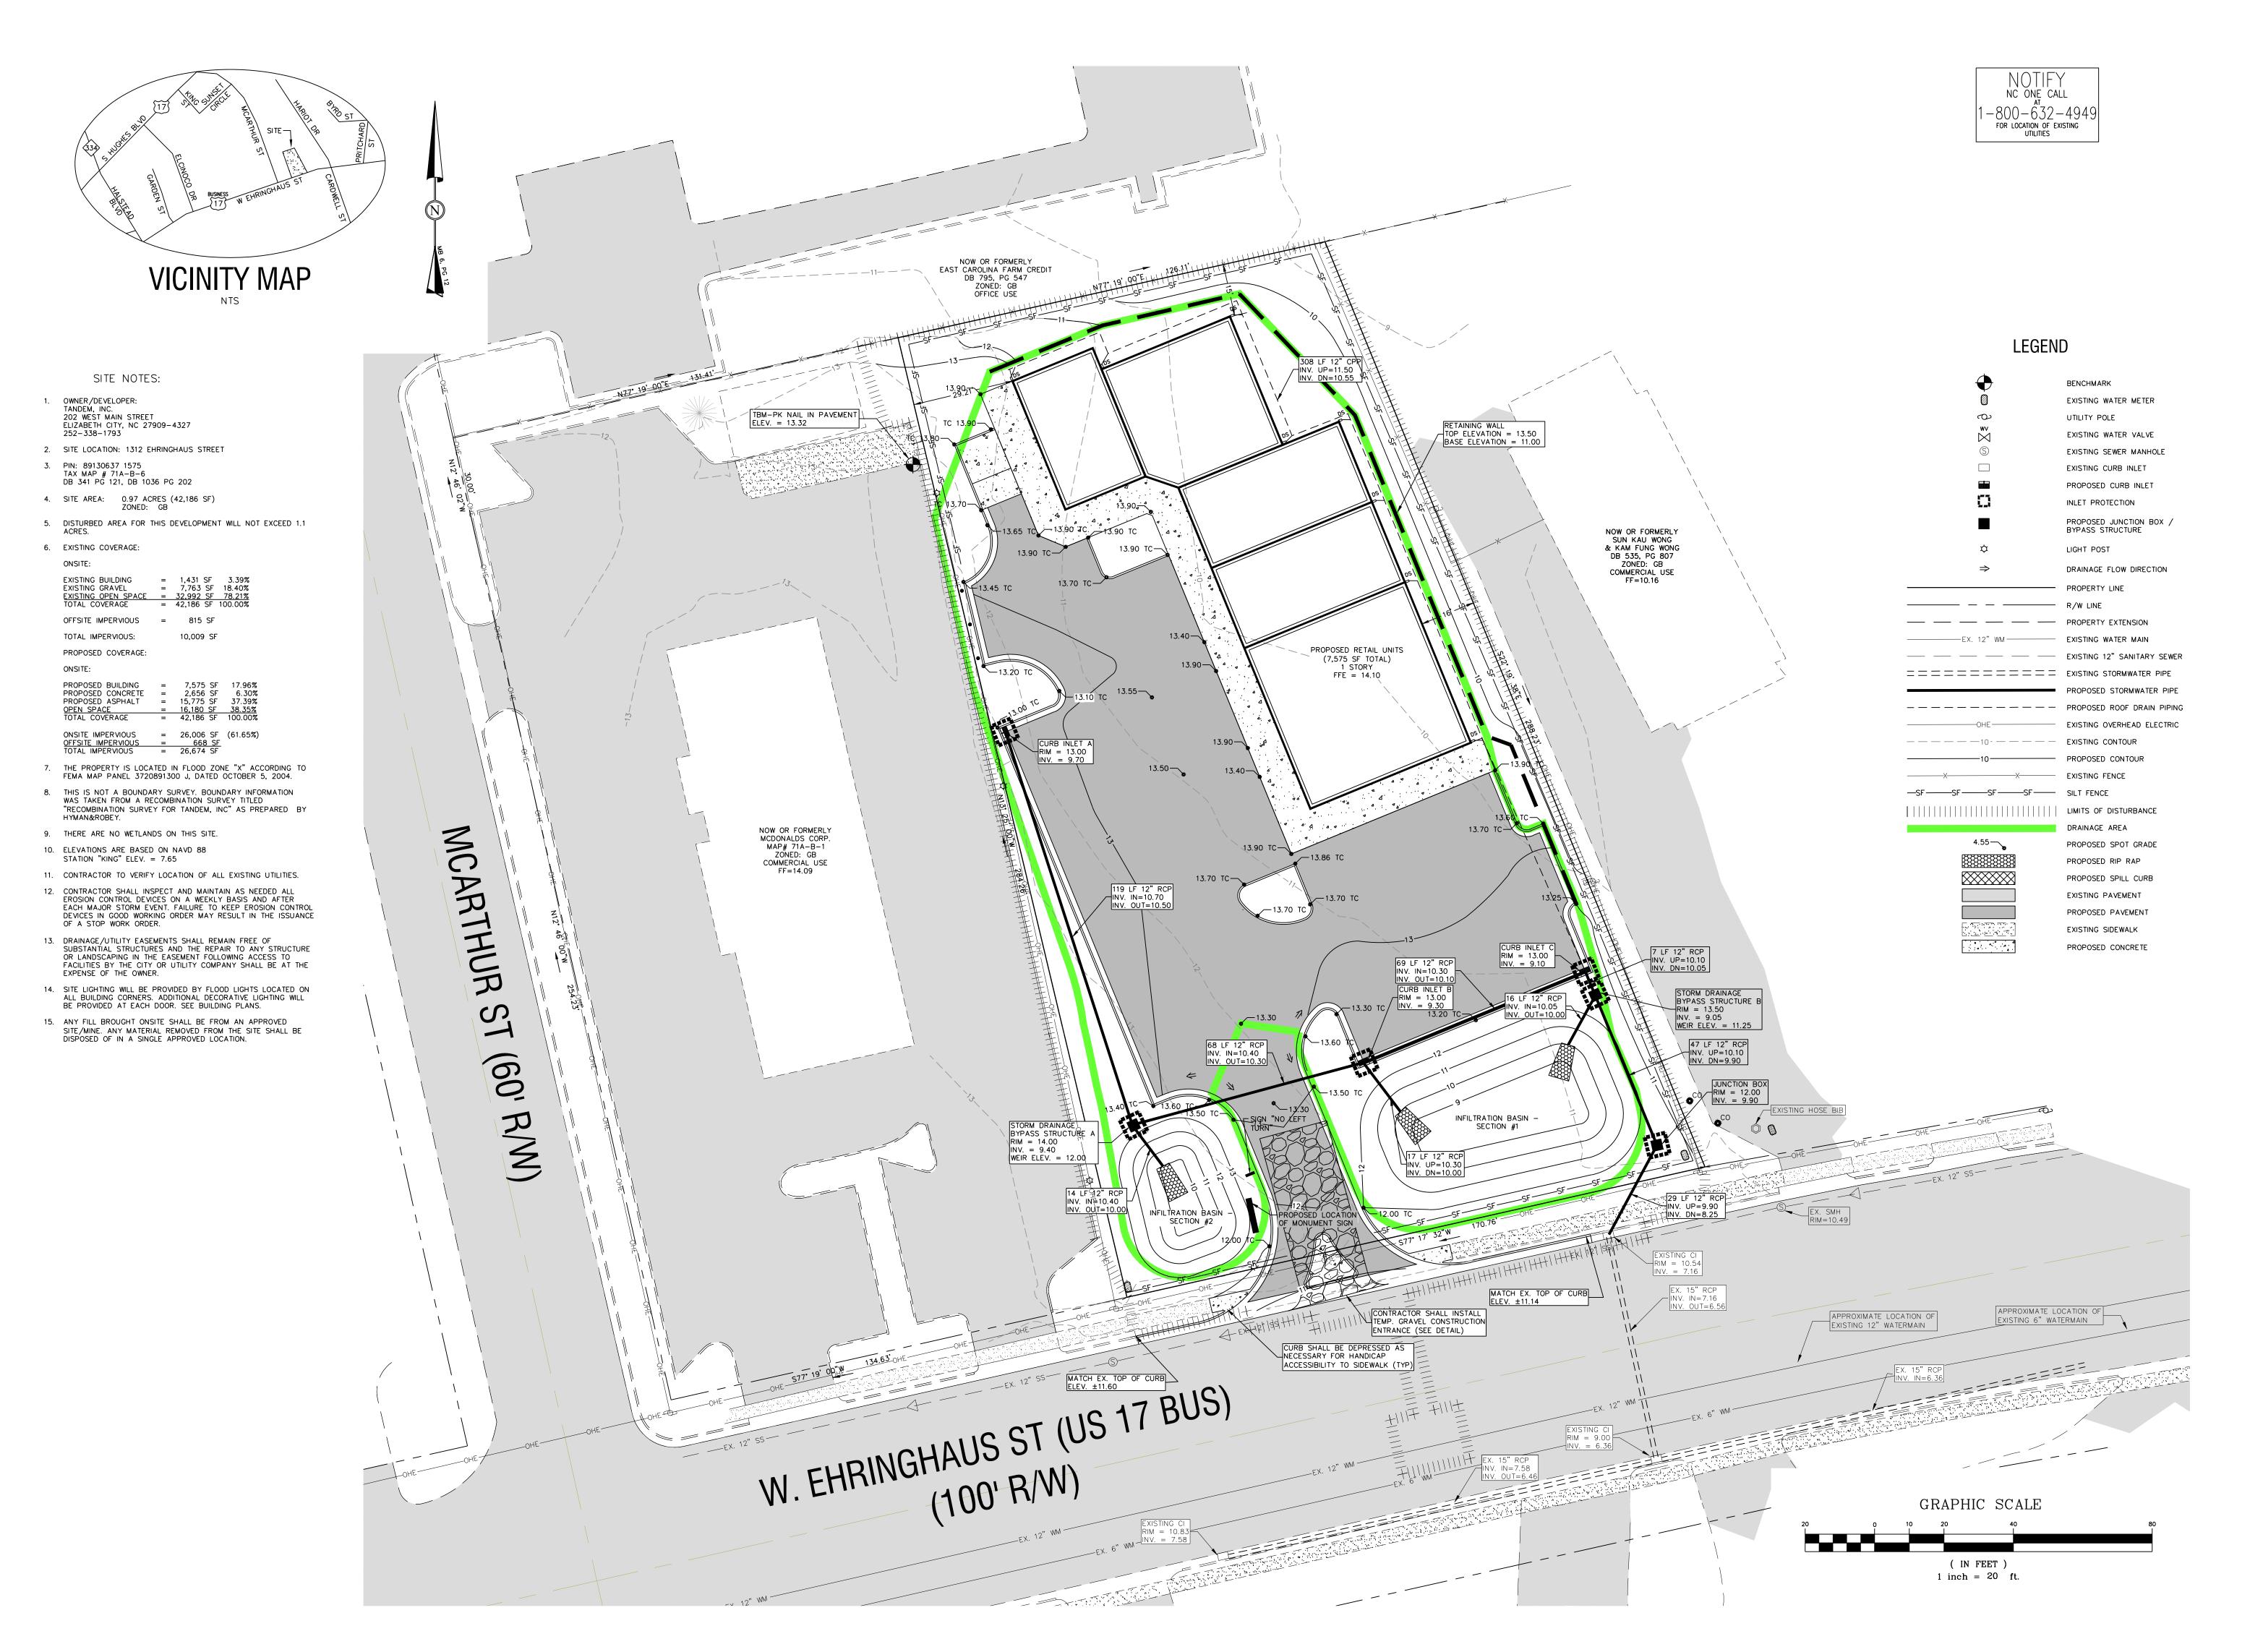





Tandem, Inc. Elizabeth City

> Pasquotank County

North Carolina

RELEASED FOR CONSTRUCTION KEY PLAN:

Project #: 090120 Drawing #: 090120 - Site Drawn: BLR Checked: KDH Approved: SCR Date: 08/07/09 Sheet #: 3/6

Scale: 1:20 REVISIONS: NUM. DATE 1 12-03-09

DESCRIPTION TRC & Removal of connecting drive 2 2-02-10

Per Planning and NCDOT 3 2-23-10 Released For

SHEET TITLE: Grading & **Erosion Control**

SHEET NUMBER:

- 1. INSTALL TEMPORARY GRAVEL CONSTRUCTION ENTRANCE PADS. (SEE DETAIL)
- INSTALL EROSION CONTROL DEVICES AT SITE DISCHARGE POINTS TO PREVENT
- 3. FILL THE SITE AND INSTALL STORM DRAINAGE PIPING, INSTALL TEMPORARY PLUGS IN PIPES THAT DISCHARGE TO INFILTRATION BASIN.
- 4. INSTALL THE REMAINING SEDIMENT AND EROSION CONTROL PROTECTION.
- 5. INSTALL THE STONE BASE AND ASPHALT FOR THE PROPOSED PARKING LOT.
- 6. CONSTRUCT INFILTRATION BASIN.

1. CONSTRUCT THE SEDIMENT BARRIER OF STANDARD STRENGTH OR EXTRA STRENGTH SYNTHETIC FILTER FABRICS.

WATER SUFFICIENT TO CAUSE FAILURE OF THE STRUCTURE.)

SHOULD HAVE MINIMUM 50 POUND TENSILE STRENGTH.

STRENGTH AND A 6 MONTH UV PROTECTION RATING.

10. DO NOT ATTACH FILTER FABRIC TO EXISTING TREES.

2. ENSURE THAT THE HEIGHT OF THE SEDIMENT FENCE DOES NOT EXCEED 24

INCHES ABOVE THE GROUND SURFACE. (HIGHER FENCES MAY IMPOUND VOLUMES OF

OF THE BARRIER TO AVOID JOINTS. WHEN THE JOINTS ARE NECESSARY, SECURELY

SECURELY TO THE UPSLOPE SIDE OF THE POSTS. EXTEND THE WIRE MESH SUPPORT

WHEN A WIRE MESH SUPPORT FENCE IS USED, SPACE POSTS A MAXIMUM OF 8

TO THE BOTTOM OF THE TRENCH. FASTEN THE WIRE REINFORCEMENT, THEN THE

FABRIC ON THE UPSLOPE SIDE OF THE FENCE POST. WIRE OR PLASTIC ZIP TIES

FEET APART. SUPPORT POSTS SHOULD BE DRIVEN SECURELY INTO THE GROUND A

7. EXCAVATE A TRENCH APPROXIMATELY 4 INCHES WIDE AND 8 INCHES DEEP ALONG THE PROPOSED LINE OF POSTS AND UPSLOPE FROM THE BARRIER

8. PLACE 12 INCHES OF THE FABRIC ALONG THE BOTTOM SIDE OF THE TRENCH.

COMPACT, THOROUGH COMPACTION OF THE BACKFILL IS CRITICAL TO SILT FENCE

9. BACKFILL THE TRENCH WITH SOIL PLACED OVER THE FILTER FABRIC AND

6. EXTRA STRENGTH FILTER FABRIC WITH 6 FEET POST SPACING DOES NOT REQUIRE WIRE MESH SUPPORT FENCE. SECURELY FASTEN THE FILTER FABRIC DIRECTLY TO POSTS. WIRE OR PLASTIC ZIP TIES SHOULD HAVE MINIMUM 50 POUND TENSILE

FASTEN THE FILTER CLOTH ONLY AT A SUPPORT POST WITH 4 FEET MINIMUM OVERLAP TO THE NEXT POST.

4. SUPPORT STANDARD STRENGTH FILTER FABRIC BY WIRE MESH FASTENED

CONSTRUCT THE FILTER FABRIC FROM A CONTINUOUS ROLL CUT TO THE LENGTH

CONSTRUCTION

MINIMUM OF 24 INCHES.

- 7. PROVIDE A GROUNDCOVER (TEMPORARY OR PERMANENT) ON EXPOSED SLOPES WITHIN 21 CALENDAR DAYS FOLLOWING COMPLETION OF ANY PHASE OF GRADING; AND, A PERMANENT GROUNDCOVER FOR ALL DISTURBED AREAS WITHIN 15 WORKING DAYS OR 90 CALENDAR DAYS (WHICHEVER IS SHORTER) FOLLOWING COMPLETION OF CONSTRUCTION OR DEVELOPMENT
- REMOVE SEDIMENT FROM CURB INLETS AND REMOVE TEMPORARY PLUGS FROM PIPES TO INFILTRATION BASIN. SEDIMENT SHALL NOT BE REMOVED BY FLUSHING PIPES SUCH THAT SEDIMENT WILL ENTER THE OFF-SITE DRAINAGE SYSTEM OR THE INFILTRATION BASIN.
- 9. MONITOR AND MAINTAIN THE INSTALLED EROSION CONTROL MEASURES AND REPAIR AS NECESSARY.
- 10. ONCE VEGETATION IS ESTABLISHED, REMOVE THE CONTROL DEVICES.

CONSTRUCTION SEQUENCING

THE CONTRACTOR SHALL CUT AND DISPOSE OF WEEDS OR OTHER UNACCEPTABLE GROWTH ON THE AREAS TO BE SEEDED. UNEVEN OR ROUGH AREAS SHALL BE SHAPED AND SMOOTHED TO PROVIDE FOR EFFECTIVE SEEDING AND EASE OF MOWING. THE SOIL SHALL BE SCARIFIED TO A DEPTH OF NOT LESS THAN 5 INCHES. CLODS SHALL BE BROKEN AND THE TOP 3-4 INCHES OF THE SOIL SHALL BE WORKED INTO A SEEDBED BY THE USE OF PULVERIZERS, DRAGS, OR HARROWS. THE PREPARATION OF SEEDBEDS SHALL NOT BE DONE WHEN THE SOIL IS FROZEN OR EXTREMELY WET.

SOIL AMENDMENTS

APPLY LIME AND FERTILIZER ACCORDING TO SOIL TESTS, OR APPLY 3,000-5,000 LB/ACRE GROUND AGRICULTURAL LIMESTONE (USE THE LOWER RATE ON SANDY SOILS) AND 1,000 LB/ACRE 10-10-10 FERTILIZER.

MULCHING

APPLY 4,000 LB/ACRE GRAIN STRAW OR EQUIVALENT COVER OF ANOTHER SUITABLE MULCH. ANCHOR STRAW BY TACKING WITH ASPHALT, NETTING, ROVING, OR BY CRIMPING WITH A MULCH ANCHORING TOOL. A DISK WITH BLADES SET NEARLY STRAIGHT CAN BE USED AS A MULCHING TOOL.

MAINTENANCE

8" BLACK ZIPTIE OR

ALUMINUM TIE WITH

STEEL FENCE POST

5' - 0.85 LB. FT. T-TYPE

STEEL POST-

FILTER FABRIC -

UPSLOPE

8" MINIMUM —

SILT FENCE DETAIL

BACKFILL TRENCH

FLOW

AND COMPACT -

THOROUGHLY

IF GROWTH IS LESS THAN FULLY ADEQUATE, REFERTILIZE IN THE SECOND YEAR, ACCORDING TO SOIL TESTS OR TOPDRESS WITH 500 LB/ACRE 10-10-10 FERTILIZER. MOW AS NEEDED WHEN SERICEA IS OMITTED FROM THE MIXTURE. RESEED, FERTILIZE, AND MULCH DAMAGED AREAS IMMEDIATELY.

MAX. HEIGHT

8" DOWN & 4"

FORWARD ALONG THE TRENCH

- FILTER FABRIC

SEEDING & MULCHING

THE CONTRACTOR SHALL COMPLY WITH ALL APPLICABLE REQUIRMENTS OF THE EROSION AND SEDIMENT CONTROL STANDARDS AND SPECIFICATIONS OF THE DEPARTMENT OF NATURAL RESOURCES AND COMMUNITY DEVELOPMENT. SOIL EROSION AND SEDIMENTATION CONTROL MEASURES SHALL BE PROVIDED ON ALL AREAS OF THE SITE WHICH ARE DISTURBED OR GRADED. CONTRACTOR SHALL PROVIDE GROUND COVERS (SEE SCHEDULE BELOW) WITHIN 30 CALENDAR DAYS AFTER COMPLETION OF CONSTRUCTION WITHIN THE SPECIFIC AREAS. THE CONTROL MEASURES SHALL BEGIN PRIOR TO ANY LAND DISTURBING ACTIVITY INCLUDING CLEARING; SHALL CONTINUE DURING THE CONSTRUCTION AND SHALL CONTINUE WITH THE NECESSARY MAINTENANCE UNTIL THE DISTURBED LAND IS STABILIZED. COMPLIANCE WITH LOCAL AND/OR STATE SOIL EROSION AND SEDIMENTATION CONTROL LAWS SHALL BE THE ENTIRE RESPONSIBILITY OF THE CONTRACTOR. THIS PARAGRAPH IS INTENDED TO SERVE ONLY AS A GUIDE TO THE CONTRACTOR FOR COMPLIANCE WITH SUCH LAWS. ORDERS, RULES AND REGULATIONS CONCERNING EROSION AND SEDIMENTATION CONTROL PROTECTION OF EXISTING STRUCTURES AND FACILITIES FROM SEDIMENTATION SHALL BE THE RESPONSIBILITY OF THE CONTRACTOR. ITEMS TO BE PROTECTED SHALL INCLUDE, BUT ARE NOT LIMITED TO CATCH BASINS, NATURAL WATERWAYS, DRAINAGE DITCHES, WALKS, DRIVES, ROADS, LAWNS, AND STREAMS.

EROSION CONTROL MEASURES

SEEDING MIXTURE RATE (LF/ACRE)

PENSACOLA BAHIAGRASS SERICEA LESPEDEZA KOBE LESPEDEZA

SEEDING NOTES 1. FROM SEPT. 1 - MAR. 1, USE UNSCARIFIED SERICEA SEED

2. ON POORLY DRAINED SITES, OMIT SERICEA AND INCREASE KOBE TO 30 LB/ACRE. 3. WHERE A NEAT APPEARANCE IS DESIRED, OMIT SERICEA AND INCREASE KOBE TO 40 LB/ACRE.


BETWEEN APRIL 15 AND AUG. 15, ADD 10 LB/ACRE GERMAN MILLET OR 15 LB/ACRE SUDANGRASS. PRIOR TO MAY 1 OR AFTER AUG. 15, ADD 25 LB/ACRE RYE (GRAIN).


FEB. 15-MAR. 20

FEB. 15-APR. 30

SEEDING SCHEDULE

CLASS B EROSION CONTROL STONE STONE DEPTH = 24" TOP OF BANK DITCH BOTTOM TOP OF BANK

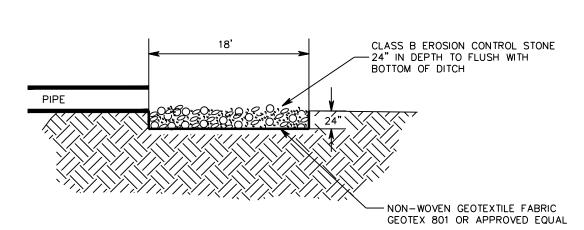

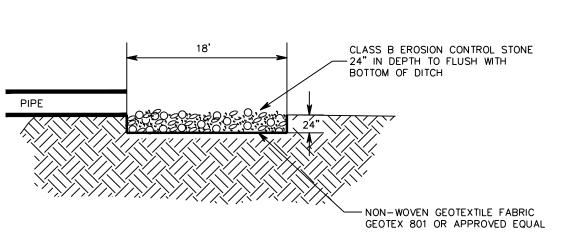

ROCK ENERGY DISSIPATER

HARDWARE CLOTH - GEOTEX 2130 OR APPROVED EQUAL TO BE PLACED 6" OUTSIDE THE BOUNDARIES OF DRAINAGE BLOCK. — DEWATERING TEMPORARY SEDIMENT POOL


BLOCK AND GRAVEL INLET PROTECTION

SECTION VIEW

A. NCDOT #5 OR #57 WASHED STONE SHALL BE USED. PAD TO BE 50' X 20' X 6" DEPTH MIN. B. TURNING RADIUS SUFFICIENT TO ACCOMODATE LARGE TRUCKS TO BE PROVIDED. C. ENTRANCE(S) SHALL BE LOCATED TO PROVIDE FOR MAXIMUM UTILITY BY ALL CONSTRUCTION VEHICLES.

D. PAD MUST BE MAINTAINED IN A CONDITION WHICH WILL PREVENT TRACKING OR DIRECT FLOW OF MUD

ONTO STREETS. PERIODIC TOPDRESSING WITH STONE WILL BE NECESSARY. E. ANY MATERIAL WHICH IS TRACKED ONTO ADJACENT ROAD SHALL BE REMOVED IMMEDIATELY.

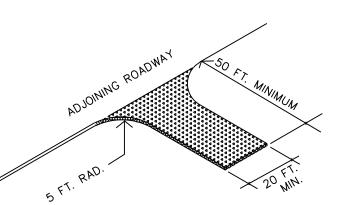

TEMPORARY GRAVEL CONSTRUCTION ENTRANCE

CONSTRUCTION SPECIFICATIONS:

THROUGH BLOCK OPENINGS.

RECOMMENDED.

OPENINGS TO HOLD GRAVEL IN PLACE.

LAY ONE BLOCK ON EACH SIDE OF THE STRUCTURE

EXCAVATED AT LEAST 2 INCHES BELOW THE CREST OF THE STORM DRAIN. PLACE THE BOTTOM ROW OF BLOCKS

AGAINST THE EDGE OF THE STORM DRAIN FOR LATERAL

SUPPORT AND TO AVOID WASHOUTS WHEN OVERFLOW

SUBSEQUENT ROWS BY PLACING 2 X 4 WOOD STUDS

2. CAREFULLY FIT HARDWARE CLOTH OR COMPARABLE

WIRE MESH WITH 1/2-INCH OPENINGS OVER ALL BLOCK

ON ITS SIDE IN THE BOTTOM ROW TO ALLOW POOL

DRAINAGE. THE BLOCK FOUNDATION SHOULD BE

OCCURS. IF NEEDED, GIVE LATERAL SUPPORT TO

3. USE CLEAN GRAVEL, 3/4- TO 1/2-INCH IN

DIAMETER, PLACED 2 INCHES BELOW THE TOP OF THE

BLOCK ON A 2:1 SLOPE OR FLATTER AND SMOOTH IT TO AN EVEN GRADE. NCDOT #57 WASHED STONE IS

Pasquotank

Tandem, Inc.

Elizabeth City

SOLUTIONS FROM THE GROUND UP

150 US Hwy 158 E.

Camden, NC 27921

(252) 338-5552 fax

www.hymanrobey.com

(252) 338-2913

PO Box 339

North Carolina

- CONCRETE BLOCK PLAN VIEW - CONCRETE BLOCK

GRAVEL FILTER - NCDOT

- GRAVEL FILTER - NCDOT #57 WASHED STONE

#57 WASHED STONE

RELEASED FOR CONSTRUCTION KEY PLAN:

Project #: 090120 Drawing #: 090120 Details Drawn: BLR Checked: KDH Approved: SCR Date: 08/07/09


Sheet #: 4/6 Scale: 1:20 **REVISIONS:** NUM. DATE


DESCRIPTION 1 12-03-09 TRC & Removal of connecting drive 2 2-23-10 Released For

Construction SHEET TITLE:


Details


SHEET NUMBER:

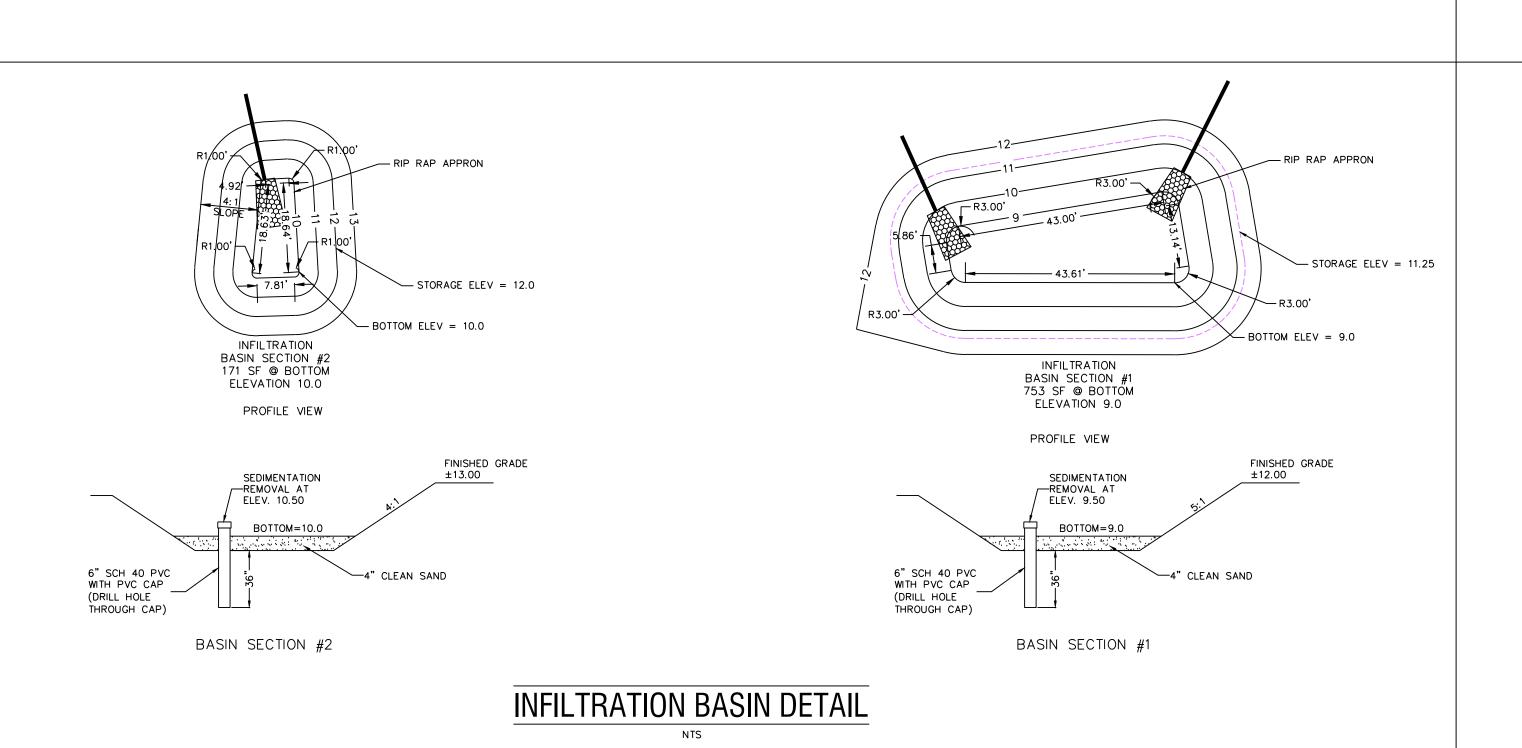

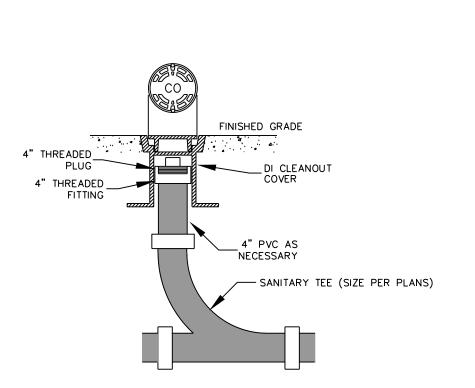

SANITARY SEWER CLEAN-OUT

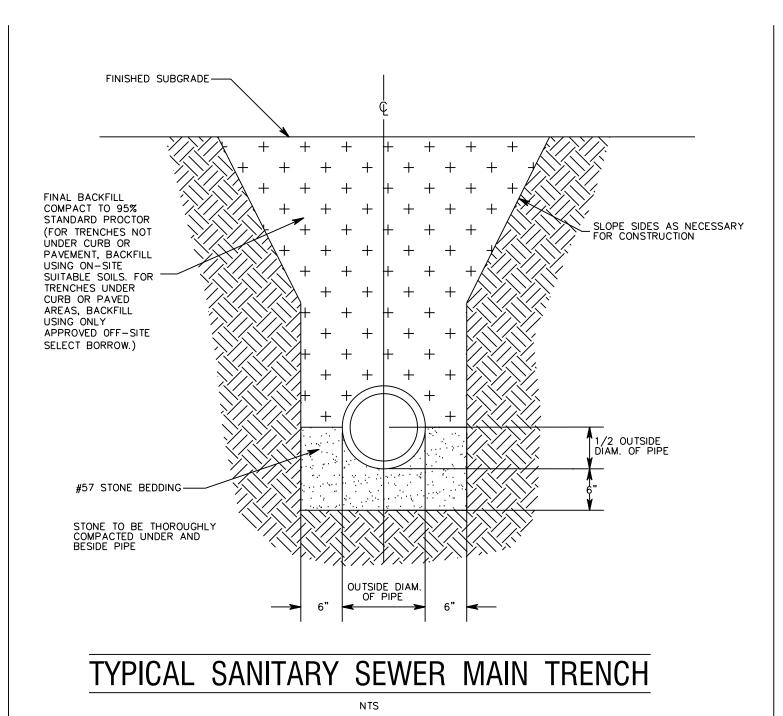

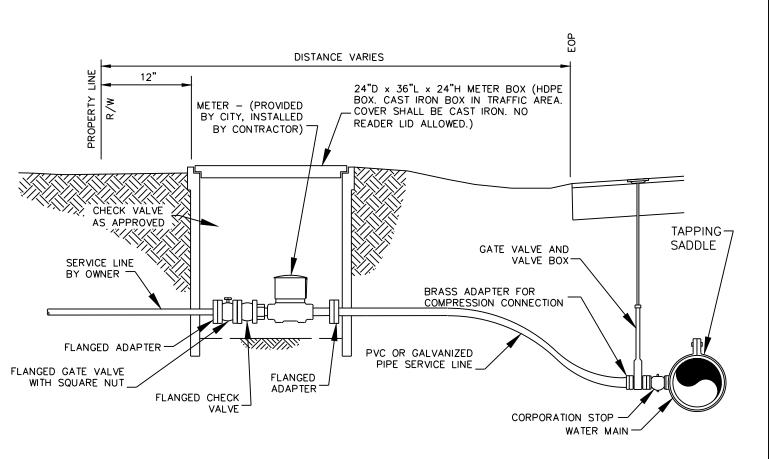

2" TO 3" WATER SERVICE CONNECTION DETAIL

ROADWAY SHOULDER

18" DIA. 6" THICK
CONCRETE "DONUT"

VALVE
BOX

CONTRACTOR SHALL USE
45' BENDS AS NECESSARY

COVER PROPOSED WATERLINE
WITH BAGS OF CONCRETE MIX, UNOPENED,
BY PLACING ONE BAG CENTERED
ON BOTH PIPES AND PLACING ONE BAG ON EACH SIDE

NOTE: ALL FITTINGS ARE TO BE BLOCKED PER THE SPECIFICATIONS.

CULVERT CROSSING DETAIL

(252) 338-2913 (252) 338-5552 fax www.hymanrobey.com SEAL 18550 C. ROBERTALLING

150 US Hwy 158 E. PO Box 339

Camden, NC 27921


Tandem, Inc.

Elizabeth City

Pasquotank

North Carolina

County

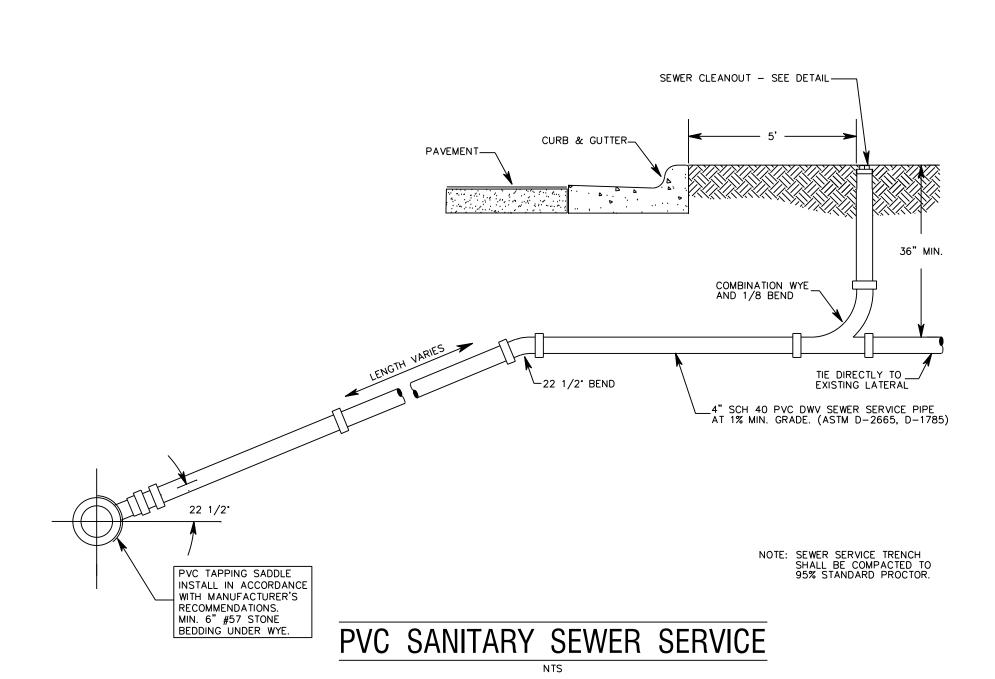

2" TYPE SF 9.5 A ASPHALT

3" TYPE I-19.0 B ASPHALT

6" ABC STONE


12" MAX

APPROVED OFF-SITE SELECT BORROW

PAVEMENT REPAIR DETAIL

NTS

PLAN UTILITY LAYOUT

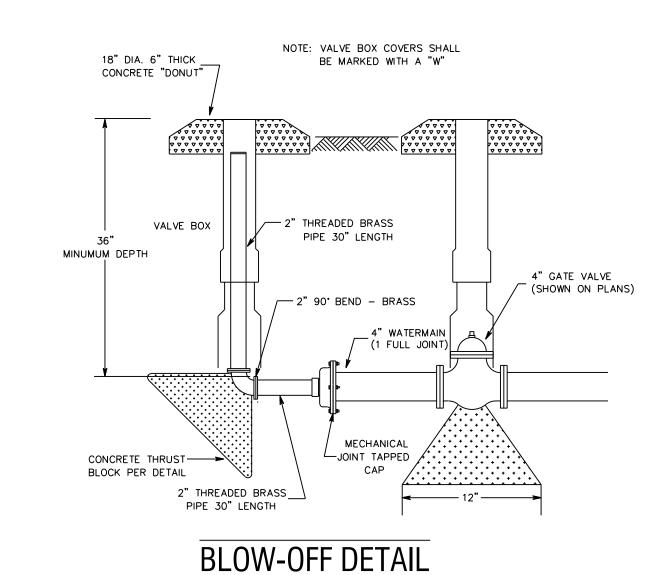

A. CITY OF ELIZABETH CITY UTILITY EASEMENT

 A UTILITY EASEMENT FOR THE INSTALLATION, MAINTENANCE AND OPERATING OF SERVICES SHALL BE DESIGNATED AS SHOWN ON PLANS.

THE INSTALLATION OF UNDERGROUND SERVICE LINES SHALL BE COORDINATED WITH THE APPROPRIATE UTILITY COMPANY. THE OWNER, CONTRACTOR, OR DEVELOPER SHALL CONTACT THE SERVICE SUPPLIER PRIOR TO THE INSTALLATION OF ANY SERVICE, TEMPORARY OR PERMANENT. THE SUPPLIER OF SAID SERVICE SHALL THEREAFTER BE DEEMED TO HAVE A DEFINITE AND PERMANENT EASEMENT ON THE PROPERTY CONSISTING OF A FIVE (5) FOOT STRIP EXTENDING TWO AND ONE HALF (2.5) FEET ON EACH SIDE OF THE SERVICE LINE. THIS EASEMENT WILL EXTEND FROM THE SERVICE EQUIPMENT TO THE SERVICE ENTRANCE AT THE STRUCTURE. THE PURPOSE OF THIS EASEMENT IS FOR THE INSTALLATION, MAINTENANCE, AND REPAIR OF SERVICE EQUIPMENT.

B. INSTALLATION

1. ELECTRIC POWER, NATURAL GAS, CABLE TELEVISION, AND TELEPHONE LINES SHALL BE INSTALLED WITHIN THE TWENTY (20) FOOT EASEMENT IN ACCORDANCE WITH THE PLAN UTILITY LAYOUT AS SHOWN HEREON, WITH THE EXCEPTION OF ROAD CROSSINGS.

- 2. ALL CABLES, CONDUITS, PIPES, AND TUBING FOR THE SERVICE OF ELECTRIC POWER, NATURAL GAS, TELEPHONE, OR CABLE TELEVISION SHALL BE UNDERGROUND OR AS AGREED UPON BY THE SERVICE PROVIDER AND THE CUSTOMER. THE SERVICE EQUIPMENT SHALL BE ABOVE GROUND. SOME EXAMPLES OF SERVICE EQUIPMENT ARE AS FOLLOWS, BUT NOT LIMITED TO:
 - A. ELECTRIC DISTRIBUTION TRANSFORMERS, SECONDARY PEDESTALS, METER PEDESTALS, SWITCH GEAR, STREET LIGHTING POLES, TRAFFIC SIGNAL POLES AND EQUIPMENT, TELEPHONE PEDESTALS, CABLE TELEVISION PEDESTALS, RADIO ANTENNAE, VALVES.
 B. SERVICE CONNECTIONS SUCH AS GAS AND ELECTRIC METERS, TELEPHONE AND CABLE
 - TELEVISION TERMINATION ENCLOSURES.
 - C. TEMPORARY EQUIPMENT FOR EMERGENCY SERVICE OR RELATED TO A CONSTRUCTION PROJECT.
- 3. ALL PROPERTY CORNERS SHALL BE LOCATED AND CLEARLY MARKED PRIOR TO THE INSTALLATION OF ANY UTILITIES.
- 4. THE UTILITY EASEMENT SHALL BE MARKED OR SUFFICIENT REFERENCE POINTS BE INSTALLED IN ORDER THAT EACH UTILITY WILL BE CAPABLE OF DETERMINING THEIR ASSIGNED SPACE WITH THE EASEMENT.

C. ENCROACHMENTS:

1. LAWNS AND LANDSCAPING SHALL BE PERMITTED ON THE EASEMENTS. LANDSCAPING SHALL CONSIST ONLY OF LOW GROWING PLANTS OR ORNAMENTAL SHRUBBERY. TREES THAT ARE EXPECTED TO GROW TO A HEIGHT OF MORE THAN SIX (6) FEET ARE NOT PERMITTED. TREES OR VEGETATION REQUIRING HEAVY MECHANICAL EQUIPMENT TO INSTALL SHALL NOT BE PERMITTED. THE UTILITY COMPANIES SHALL NOT BE HELD RESPONSIBLE FOR DAMAGE TO LAWNS OR LANDSCAPING ON THIS EASEMENT DURING NORMAL MAINTENANCE OR EMERGENCY SERVICE

2. NO BUILDING, STRUCTURE OR PART THEREOF SHALL ENCROACH UPON THE UTILITY EASEMENT.

3. THE EASEMENT SHALL NOT BE OBSTRUCTED IN ANY WAY AS WITH THE STORAGE OR STOCK PILING OF MATERIALS SUCH AS DIRT, GRAVEL, STONE, ETC.

D. GENERA

1. THE OWNER SHALL BE RESPONSIBLE FOR THE PROTECTION OF THE UNDERGROUND FACILITIES LOCATED INSIDE THE EASEMENT ON HIS PROPERTY. THEY SHALL PREVENT ANY SUBSTANTIAL CHANGE OF GRADE OR ELEVATION AND CONSTRUCTION OF ANY KIND THAT MAY DAMAGE THE UTILITIES WITHIN THE EASEMENT.

4. DAMAGE CAUSED BY THE NEGLIGENCE OF THE OWNER OR HIS AGENTS SHALL BE THE RESPONSIBILITY OF THE OWNER. HE SHALL PAY FOR THE REPAIR, REPLACEMENT, OR RELOCATION OF THE DAMAGED FACILITY.


5. EACH UTILITY COMPANY SHALL BE RESPONSIBLE FOR THE MAINTENANCE OF THEIR UNDERGROUND


6. EACH UTILITY COMPANY THROUGH IT'S EMPLOYEES, CONTRACTORS, OR AGENTS SHALL AT ANY AND ALL TIMES HAVE ACCESS TO THE EASEMENT FOR THE PURPOSE OF INSPECTING, INSTALLING, REMOVING, REPAIRING, OR REPLACING THEIR FACILITY OR ANY PORTION THEREOF.

7. EACH UTILITY COMPANY RESERVED THE RIGHT TO NOT SUPPLY UNDERGROUND SERVICE WHEN, IN ITS JUDGEMENT, IT IS IMPRACTICAL OR CONTRARY TO SOUND OPERATING OR ENGINEERING PRACTICES TO DO SO. EXAMPLES MAY INCLUDE UNUSUALLY ROUGH TERRAIN, WET LANDS, LARGE QUANTITIES OF ROCK, OR UNSUITABLE DIGGING CONDITIONS.


8. IT IS IMPORTANT THAT CLOSE COORDINATION EXIST BETWEEN THE DEVELOPER OR OWNER AND THE DIFFERENT UTILITIES. IT IS THE RESPONSIBILITY OF THE DEVELOPER OR OWNER TO NOTIFY AND COORDINATE THE INSTALLATION OF THE UTILITIES TO ACCOMPLISH AN ORDERLY CONSTRUCTION OF THE PROPERTY


9. ALL FACILITIES SHALL BE INSTALLED AND CONSTRUCTED TO COMPLY WITH ALL APPLICABLE LOCAL, COUNTY, STATE, AND FEDERAL CODES AND REGULATIONS.

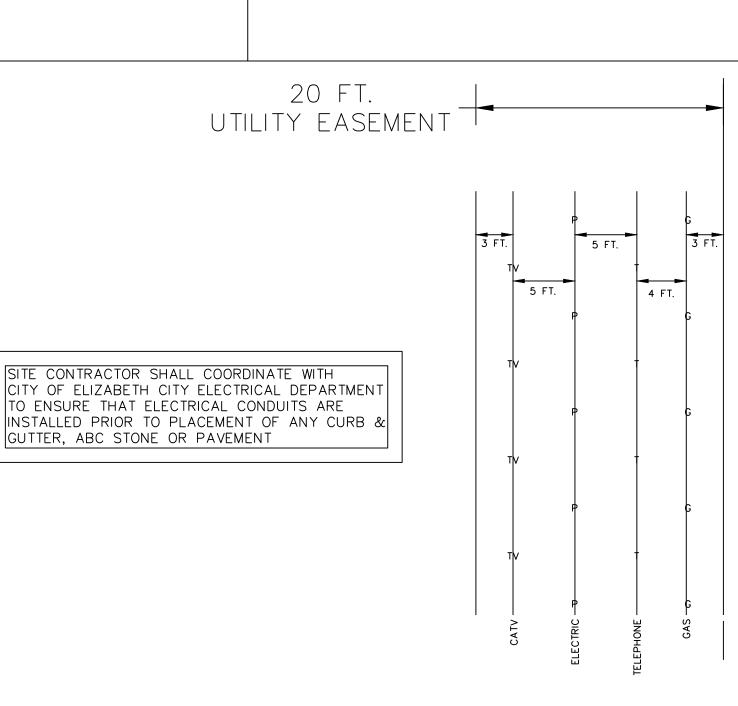

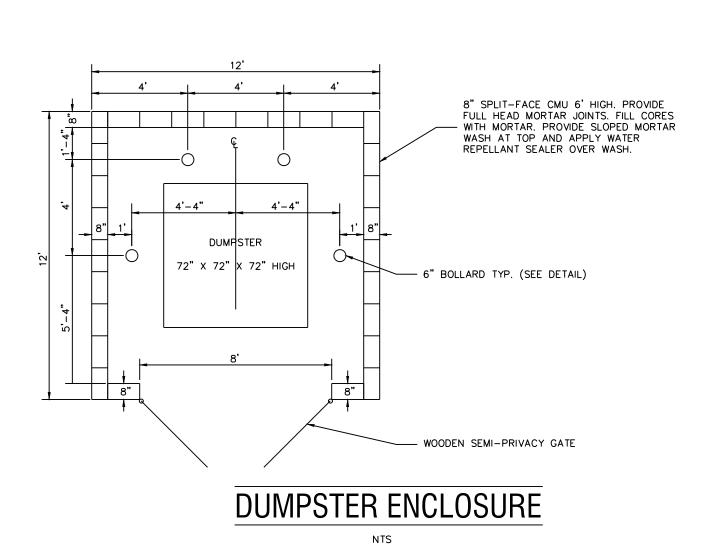



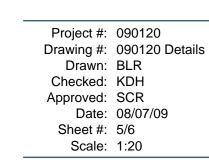

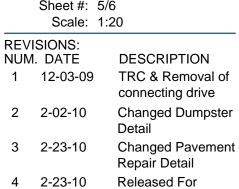


Construction


SHEET TITLE:

SHEET NUMBER:

5

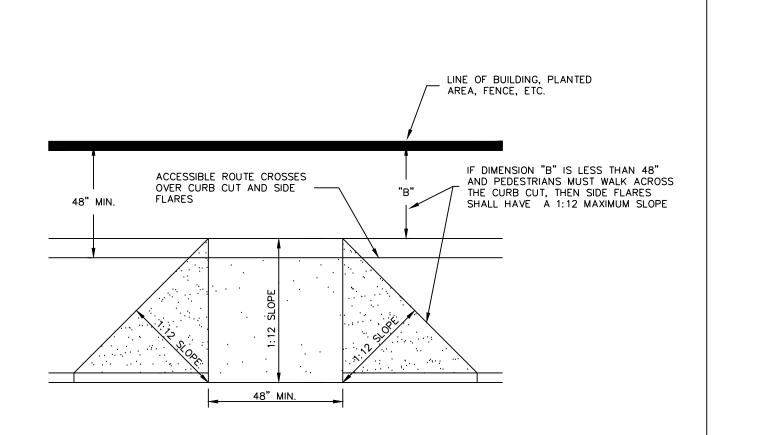



HANDICAPPED ACCESS CURB CUT

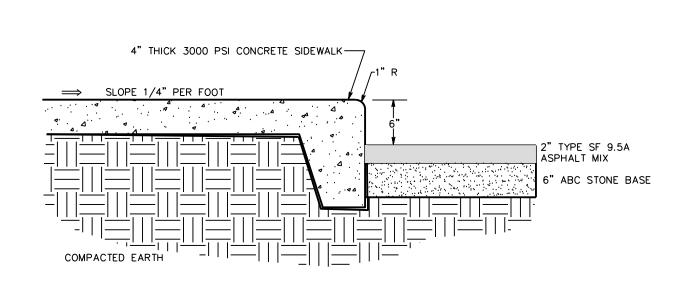


CONCRETE SIDEWALK DETAIL

C.I. FRAME AND GRATE SHALL CONFORM TO NCDOT STANDARD DRAWING 840.03

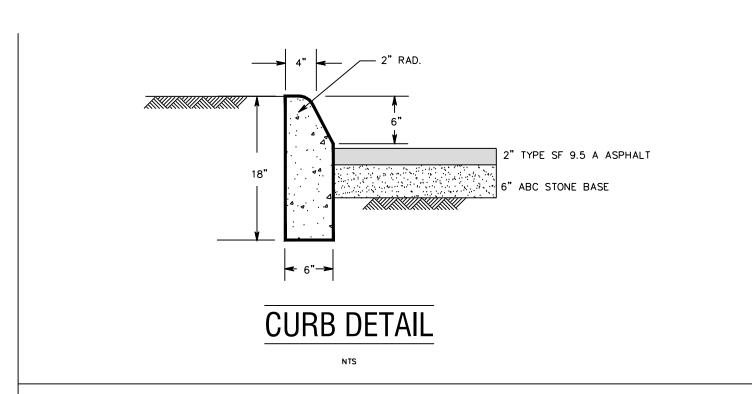

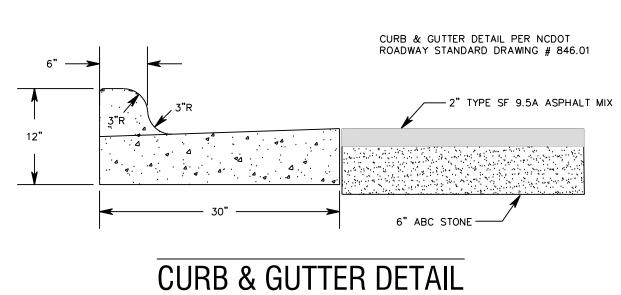

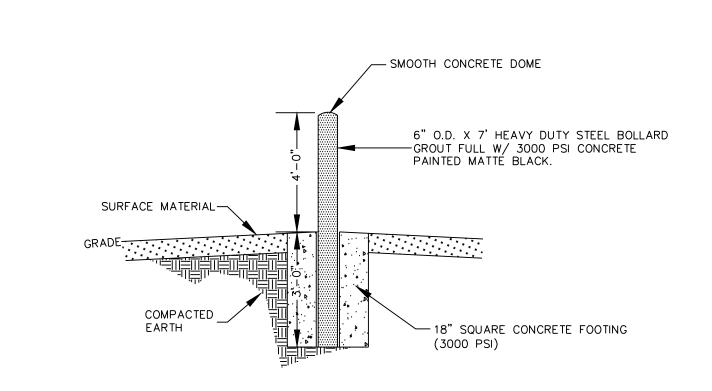



Pasquotank County

SOLUTIONS FROM THE GROUND UP

150 US Hwy 158 E.

Camden, NC 27921


(252) 338-5552 fax


www.hymanrobey.com


(252) 338-2913


PO Box 339

North Carolina

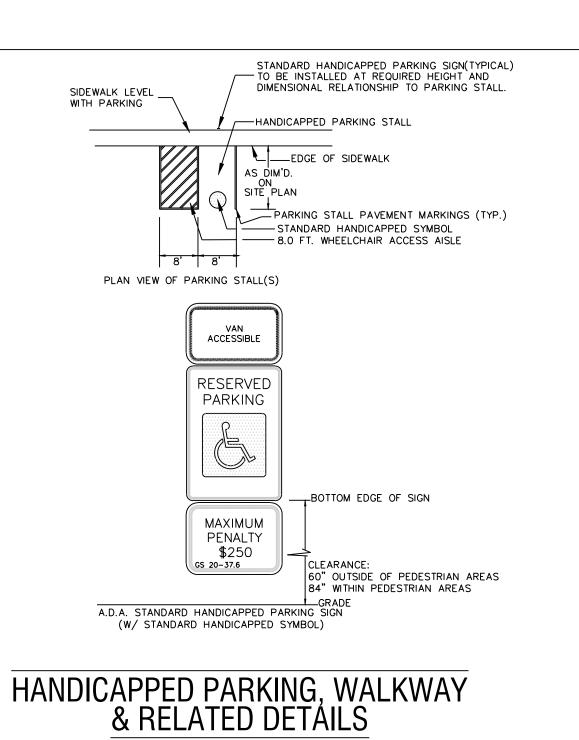


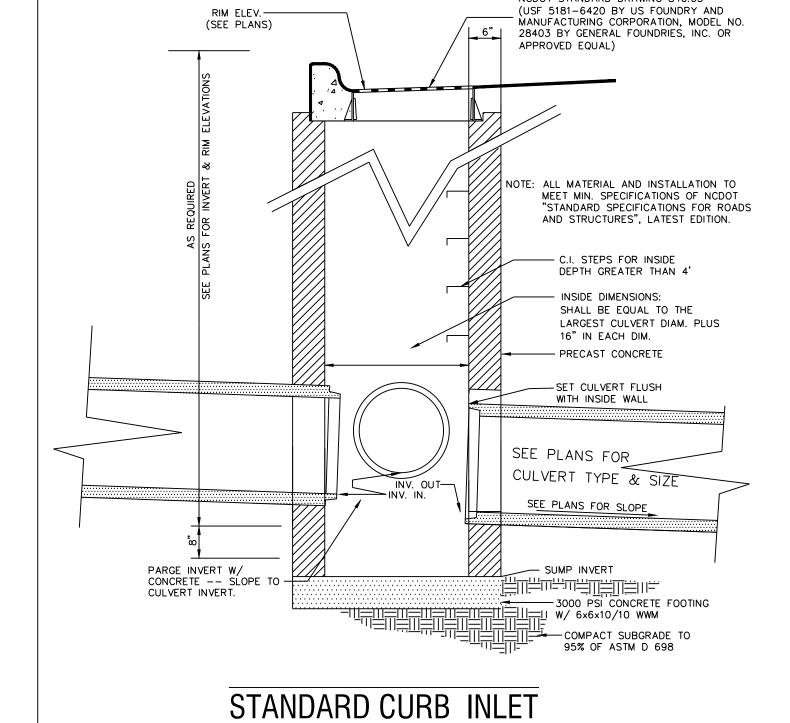

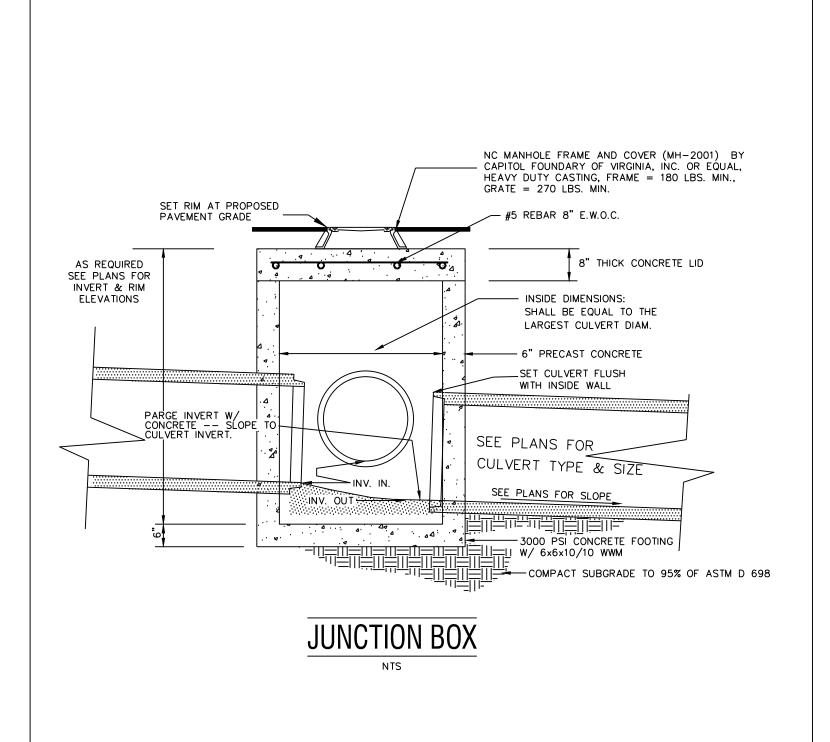


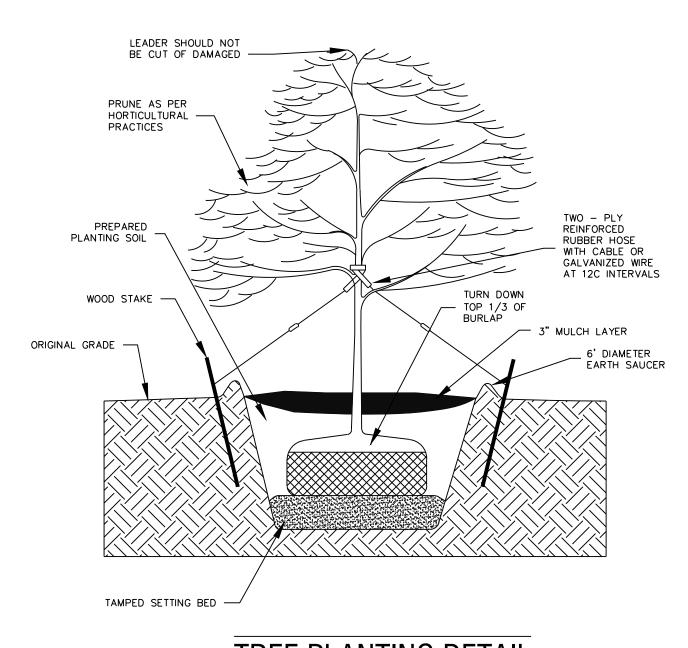


TREE PLANTING DETAIL

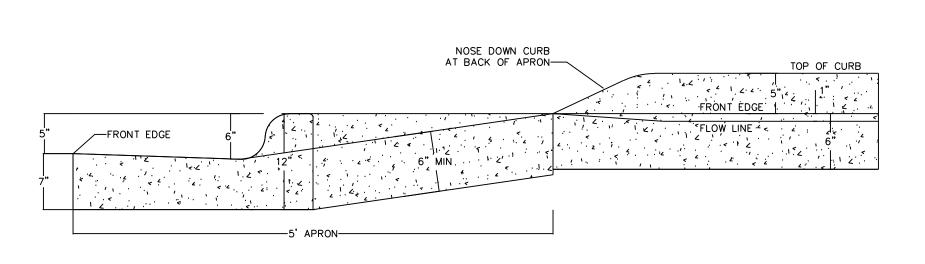

CURB TRANSITION AT DRIVEWAY APRON

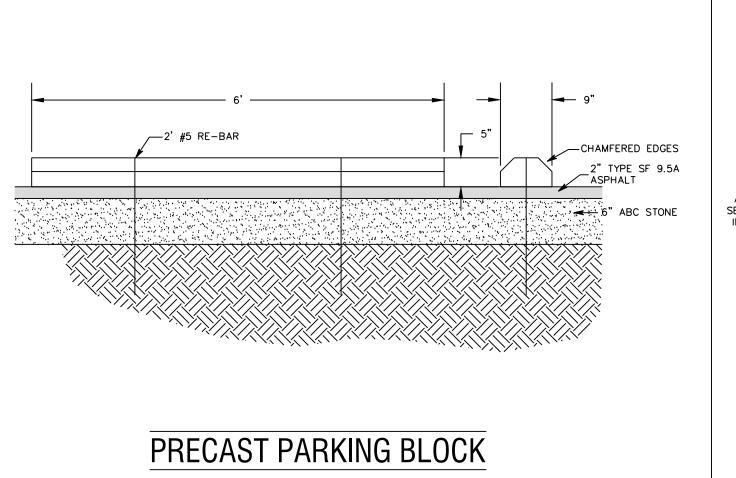

NTS

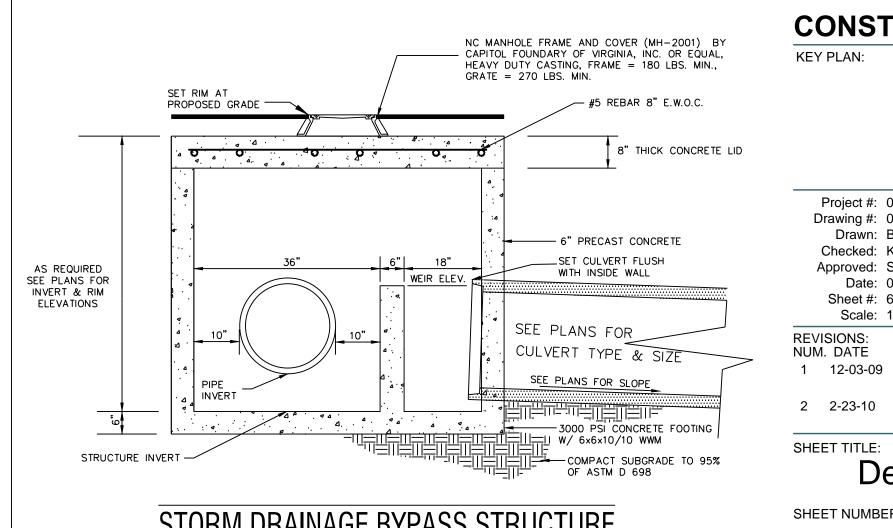

STORM DRAINAGE BYPASS STRUCTURE

CONSTRUCTION KEY PLAN: Project #: 090120 Drawing #: 090120 Details Drawn: BLR Checked: KDH Approved: SCR Date: 08/07/09 Sheet #: 6/6 Scale: 1:20 **REVISIONS:**

RELEASED

FOR

2 2-23-10 Released For Construction SHEET TITLE:


Details

SHEET NUMBER:

DESCRIPTION

TRC & Removal of

connecting drive

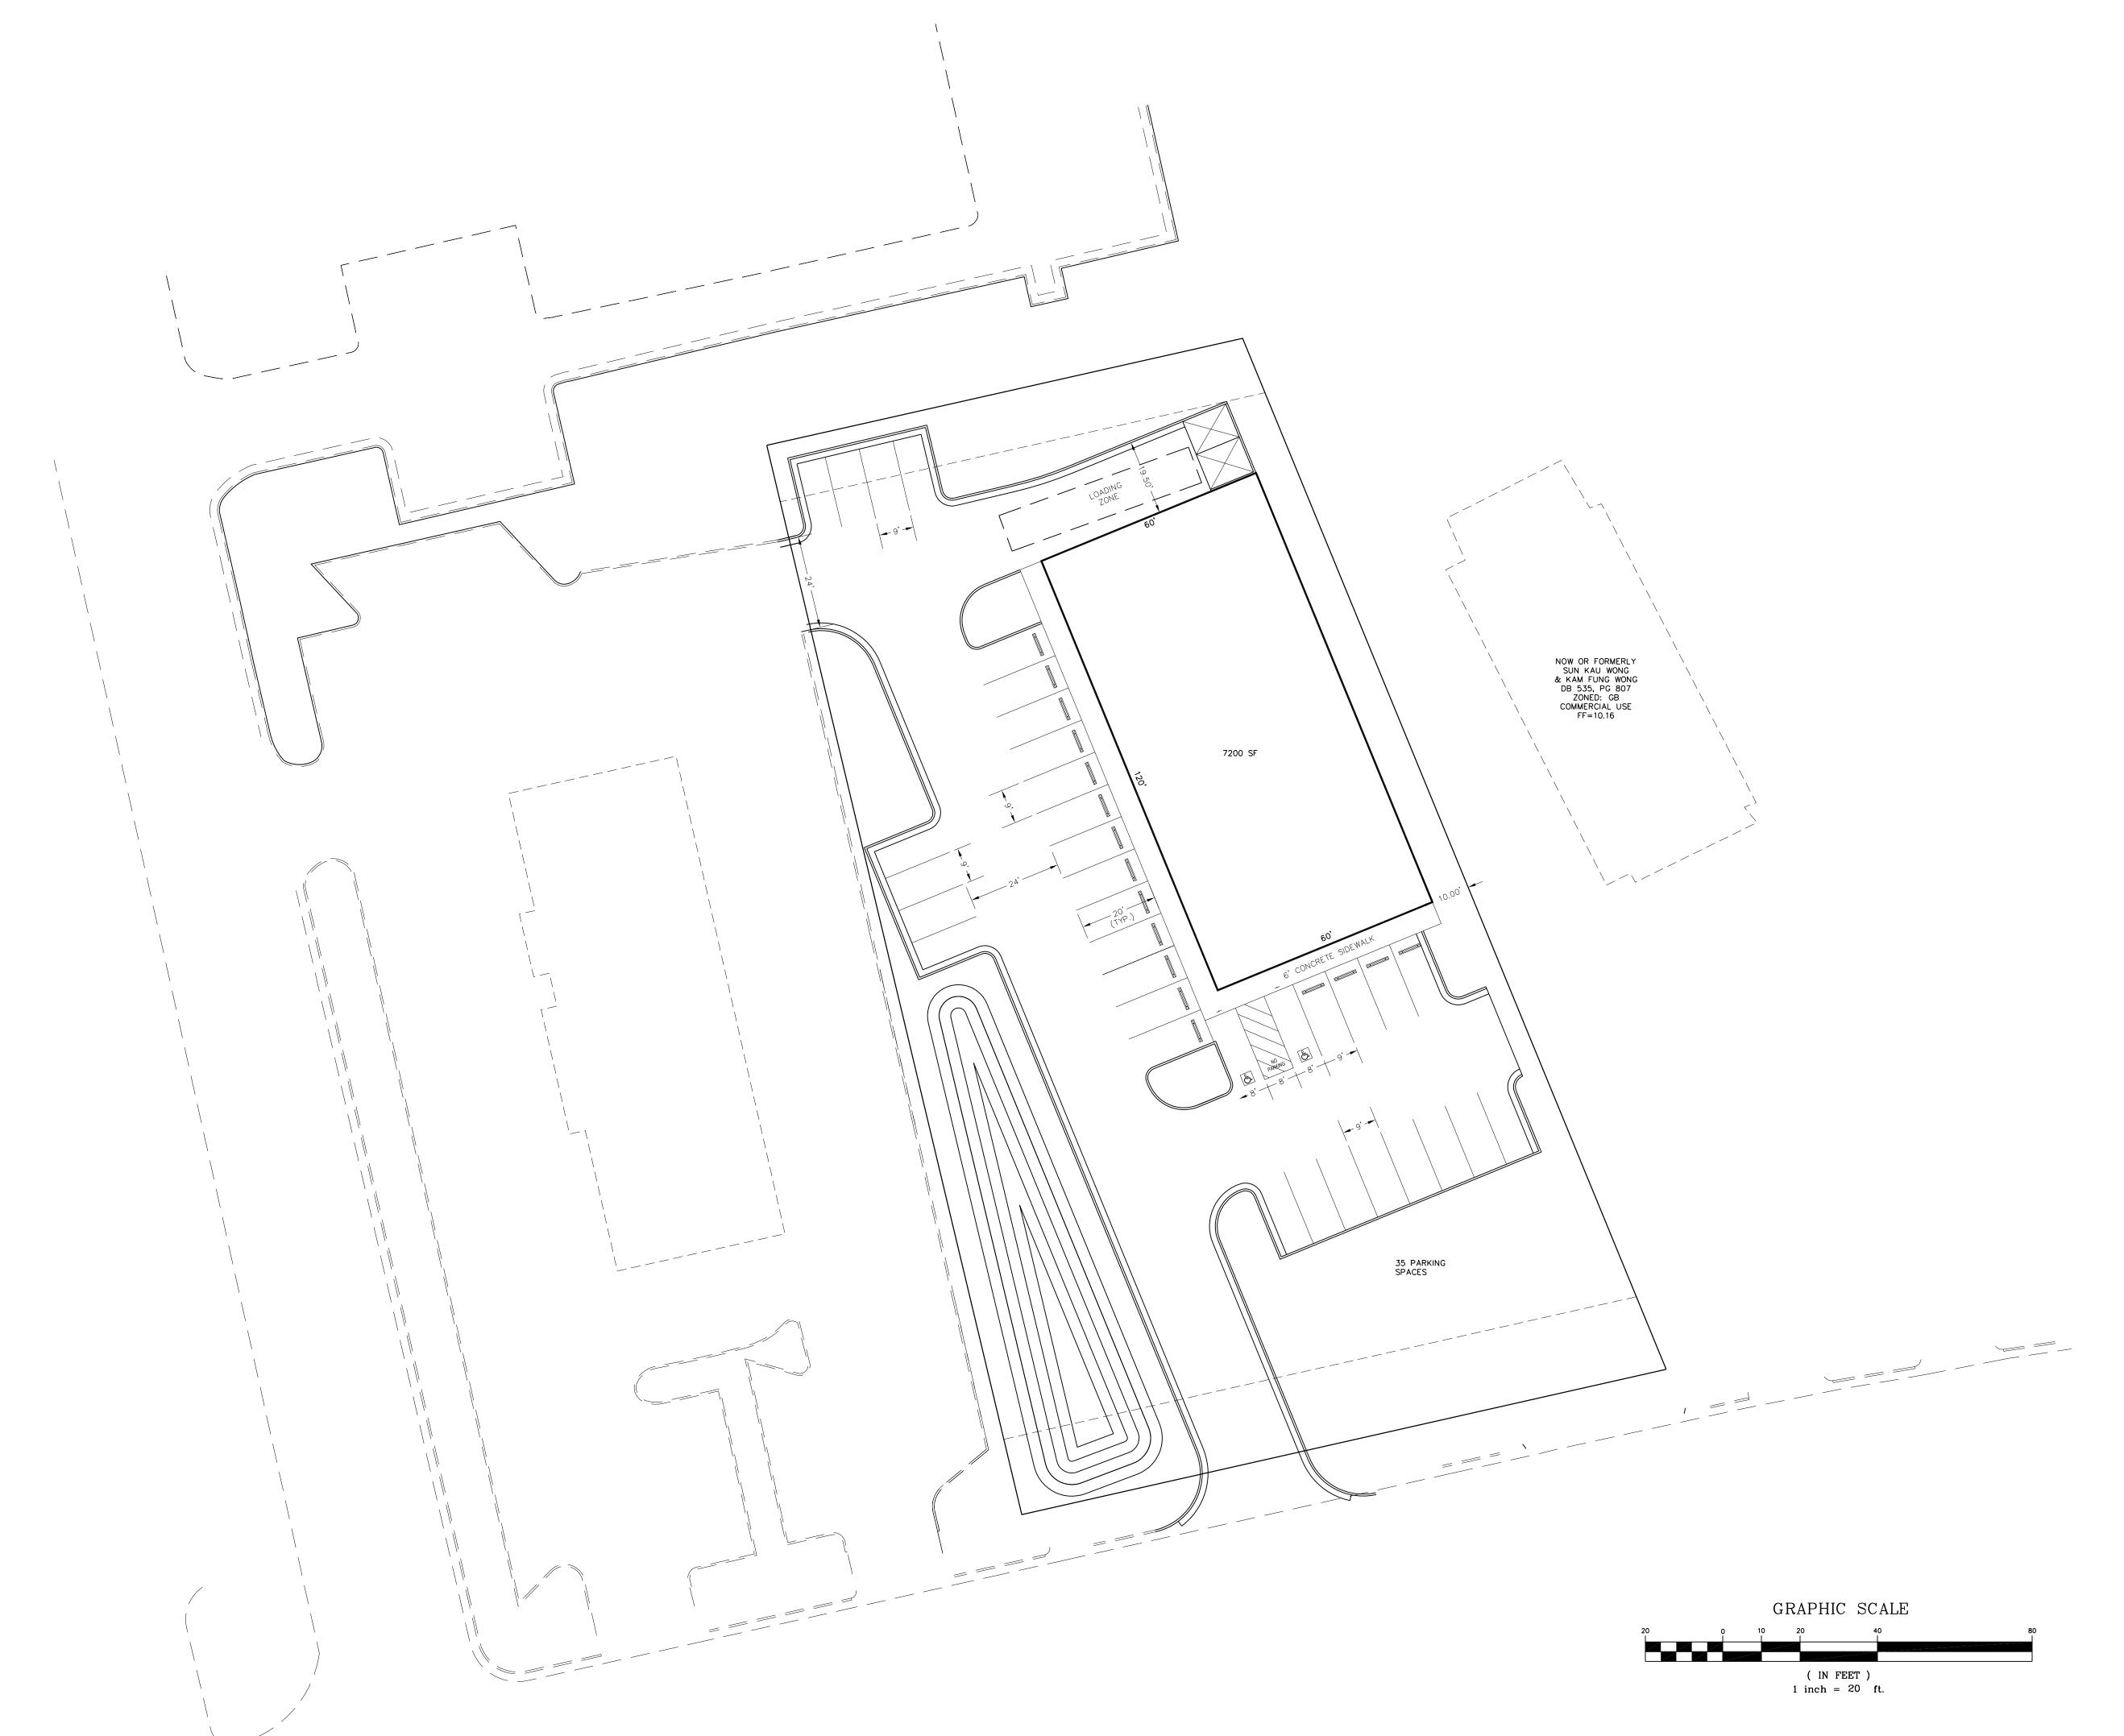





Tandem, Inc.

Elizabeth City

Pasquotank County

> North Carolina


KEY PLAN:


Project #: 090120
Drawing #: 090120 Schematic 1 unit
Drawn: JLW
Checked: KDH
Approved: SCR
Date: 06-30-09
Sheet #: 1 OF 1
Scale: 1" = 20'

REVISIONS: NUM. DATE DESCRIPTION

SHEET TITLE:
SCHEMATIC
SITE PLAN
SHEET NUMBER:

MBER:

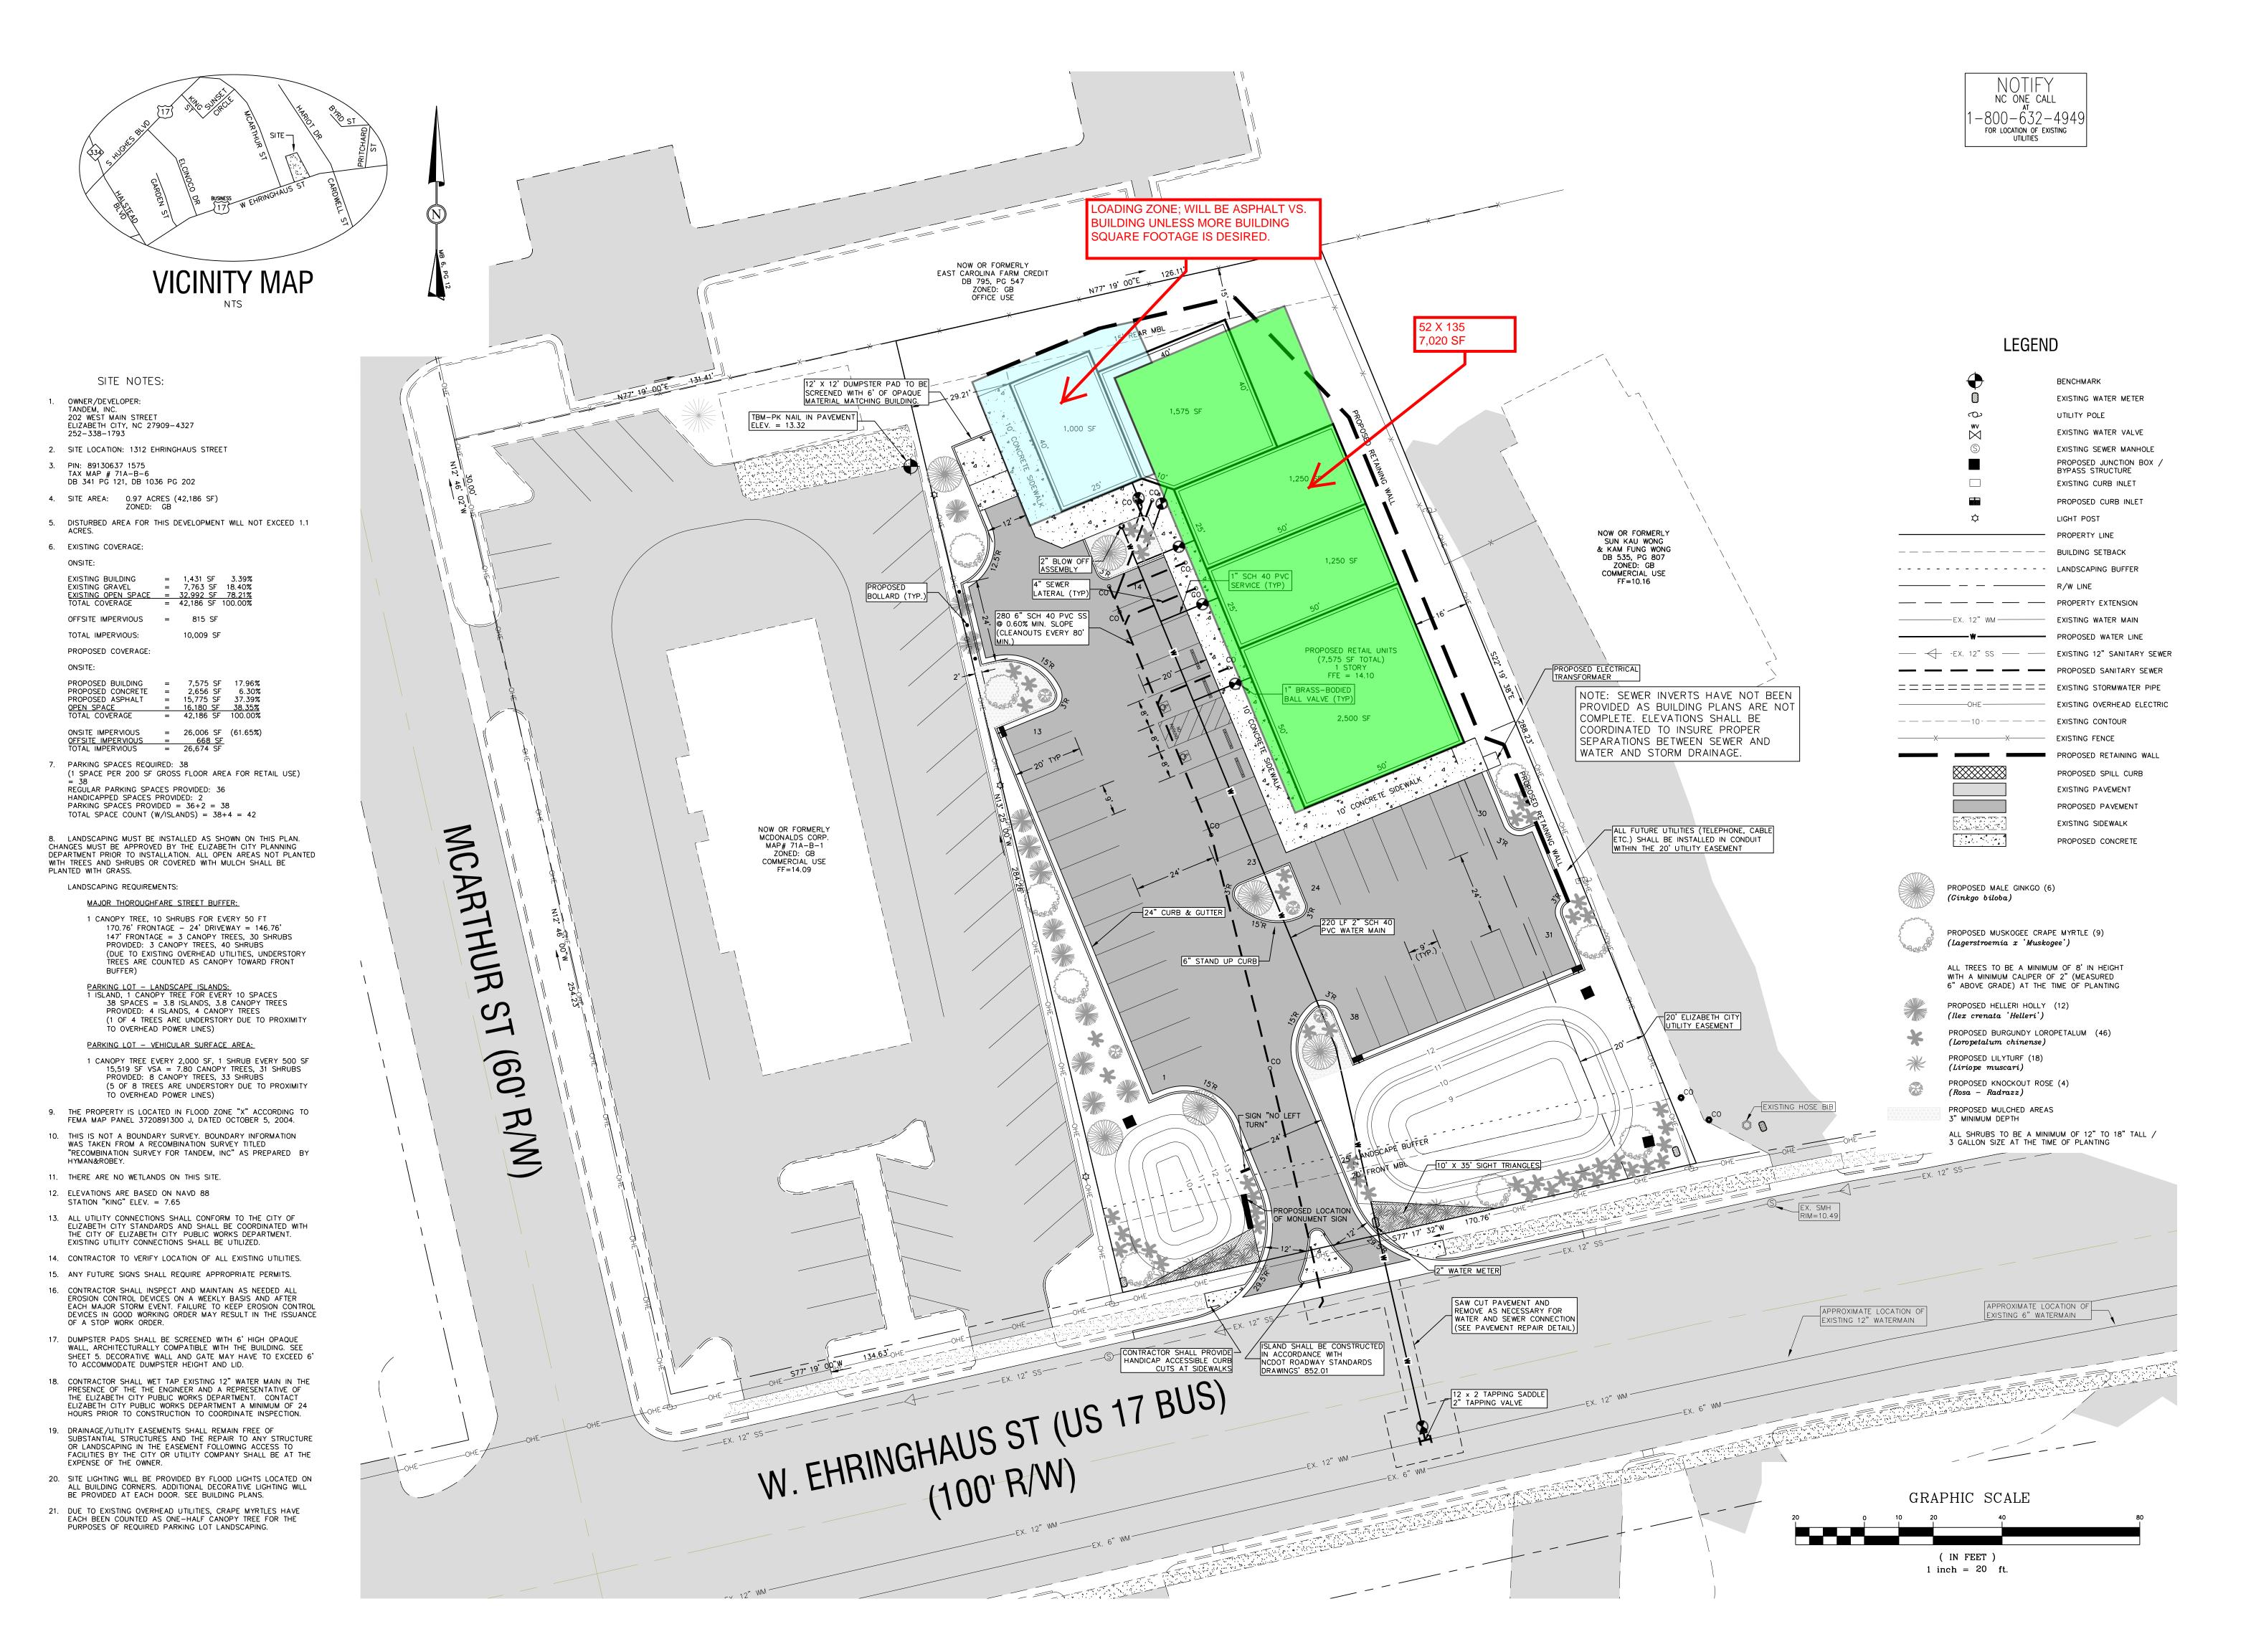

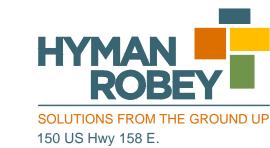





Tandem, Inc.

Elizabeth City

Pasquotank County

North Carolina

RELEASED
FOR
CONSTRUCTION
KEY PLAN:

Project #: 090120
Drawing #: 090120 - Site
Drawn: BLR
Checked: KDH
Approved: SCR
Date: 08/07/09
Sheet #: 2/6

Scale: 1:20

REVISIONS:
NUM. DATE D

NUM. DATE DESCRIPTION

1 12-03-09 TRC & Removal of connecting drive

2 2-02-10 Per Planning and NCDOT

NCDOT

3 2-23-10 Released For

Construction

SHEET TITLE:

Site & Utility
Plan

SHEET NUMBER:

2







